


# **WICKATUNK**

FA#: 14209075 - SITE#: NWL00575 **316 TENNENT ROAD MORGANVILLE, NJ 07751 MARLBORO TOWNSHIP NEW SITE BUILD** SITE PLAN APPROVAL



DIRECTIONS FROM 1 AT&T WAY, BEDMINSTER, NJ:

GET ON I-287 S FROM AT&T WAY AND US-202 S/US-206 S. CONTINUE ON I-287 S TO SAYREVILLE. TAKE EXIT 123 FROM GARDEN STATE PKWY. GET ON NJ-18 S IN OLD BRIDGE TOWNSHIP. CONTINUE ON NJ-18 S TO MARLBORO TOWNSHIP. TAKE THE EXIT TOWARD MORGANVILLE FROM NJ-18 S. FOLLOW TENNENT RD. DESTINATION WILL BE THE LEFT.

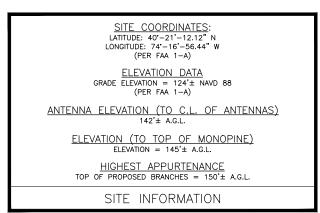

1. D-3 USE VARIANCE VARIANCES REQUESTED

LANDSCAPING BUFFER TOWER SET BACK TOWER RESIDENTIAL SETBACK

WAIVERS REQUESTED

THE PROJECT CONSISTS OF INSTALLING NEW TELECOMMUNICATIONS FACILITY WITH (1) 150'-0" MONOPINE, (1) METER PAK, (1) MESA CABINET, (1) WALK IN CABINET, (1) NATURAL GAS GENERATOR, (1) ANTENNA PLATFORM, (16)
ANTENNAS, (20) RRH UNITS, (4) SURGE ARRESTORS, (1) COMPOUND FENCE
WITH ACCESS GATE & ALL ASSOCIATED EQUIPMENT & CABLING FOR A COMPLETE INSTALLATION.

PROJECT DESCRIPTION

SITE NAME: SITE ADDRESS: 316 TENNENT ROAD MORGANVILLE, NJ 07751

TAX MAP DESIGNATION: BLOCK: 172/ LOT: 41

ZONING DESIGNATION: IOR: INDUSTRIAL-OFFICE-RESEARCH

**APPLICANT:** NEW CINGULAR WIRELESS PCS, LLS ("AT&T")

1 AT&T WAY
BEDMINSTER, NJ

> PROPERTY OWNER:
> AMBTEN ROAD ASSOCIATES, LLC 44 NIKKI COURT MORGANVILLE, NJ 07751

PROJECT INFORMATION

SITE ACQUISITION: PHONE: (518) 527-0174

PROJECT MANAGER: JOSH MOSTOW AIROSMITH DEVELOPMENT PHONE: (732) 693-3840


ENGINEER:
GREGORY NAWROTZKI DEWBERRY ENGINEERS INC PHONE: (973) 576-9653

CONTACT INFORMATION

THIS DOCUMENT WAS DEVELOPED TO REFLECT A SPECIFIC SITE AND ITS SITE CONDITIONS AND IS NOT TO BE USED FOR ANOTHER SITE OR WHEN OTHER CONDITIONS PERTAIN. REUSE OF THIS DOCUMENT IS AT THE SOLE RISK OF

A.D.A. COMPLIANCE: FACILITY IS UNMANNED AND NOT FOR HUMAN HABITATION.

SHEET NUMBER	DESCRIPTION
T-1	TITLE SHEET
G-1	GENERAL NOTES
Z-1	EXISTING CONDITIONS PLAN & NOTES
Z-2	SITE PLAN & NOTES
Z-3	ZONING INFORMATION
Z-4	LIST OF PROPERTY OWNERS
Z-5	COMPOUND PLAN & ELEVATION
Z-6	CONSTRUCTION DETAILS I
Z-7	CONSTRUCTION DETAILS II
Z-8	CONSTRUCTION DETAILS III
Z-9	CONSTRUCTION DETAILS IV
Z-10	CONSTRUCTION DETAILS V
Z-11	ANTENNA MOUNT DETAILS & NOTES
SC-1	SOIL EROSION & SEDIMENT CONTROL PLAN
SC-2	SOIL EROSION, SEDIMENT CONTROL NOTES & DETAILS

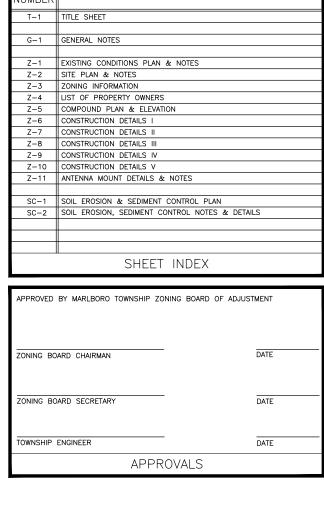



New Cingular Wireless PCS, LLC One AT&T Way Bedminster, NJ 07921



**WICKATUNK** FA#: 14209075 SITE#: NWL00575

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Dewberry Engineers Inc.

600 PARSIPPANY ROAD SUITE 301 PARSIPPANY, NJ 07054 PHONE: 973.739.9400 FAX: 973.739.9710 COA 24GA28047600



NJ LICENSE No. 24GE05408600

T IS A VIOLATION OF LAW FOR ANY PERSON, UNLE THEY ARE ACTING UNDER THE DIRECTION OF A LICENSED PROFESSIONAL ENGINEER TO ALTER THIS DOCUMENT.

DRAWN BY: JC GHN REVIEWED BY: CHECKED BY: GHN PROJECT NUMBER: 50110598

50110612 JOB NUMBER:

SITE ADDRESS:

316 TENNENT ROAD MORGANVILLE, NJ 07751 MARLBORO TOWNSHIP

SHEET TITLE

TITLE SHEET

SHEET NUMBER

|-1|

#### **GENERAL CONSTRUCTION NOTES:**

- ALL WORK SHALL CONFORM TO ALL CURRENT APPLICABLE FEDERAL, STATE, AND LOCAL CODES, INCLUDING ANSI/EIA/TIA-222, AND COMPLY WITH AT&T & SPECIFICATIONS.
- CONTRACTOR SHALL CONTACT "CALL BEFORE YOU DIG" (811) FOR IDENTIFICATION OF UNDERGROUND UTILITIES PRIOR TO START OF CONSTRUCTION.
- CONTRACTOR IS RESPONSIBLE FOR COORDINATING ALL REQUIRED INSPECTIONS.
- 4. ALL DIMENSIONS TO, OF, AND ON EXISTING BUILDINGS, DRAINAGE STRUCTURES, AND SITE IMPROVEMENTS SHALL BE VERIFIED IN FIELD BY CONTRACTOR WITH ALL DISCREPANCIES REPORTED TO THE ENGINEER.
- 5. DO NOT CHANGE SIZE OR SPACING OF STRUCTURAL ELEMENTS.
- 5. DETAILS SHOWN ARE TYPICAL; SIMILAR DETAILS APPLY TO SIMILAR CONDITIONS UNLESS OTHERWISE NOTED.
- THESE DRAWINGS DO NOT INCLUDE NECESSARY COMPONENTS FOR CONSTRUCTION SAFETY WHICH IS
  THE SOLE RESPONSIBILITY OF THE CONTRACTOR.
- 3. CONTRACTOR SHALL BRACE STRUCTURES UNTIL ALL STRUCTURAL ELEMENTS NEEDED FOR STABILITY ARE INSTALLED. THESE ELEMENTS ARE AS FOLLOWS: LATERAL BRACING, ANCHOR BOLTS, ETC.
- CONTRACTOR SHALL DETERMINE EXACT LOCATION OF EXISTING UTILITIES, GROUNDS DRAINS, DRAIN PIPES. ETC. BEFORE COMMENCING WORK.
- 10. INCORRECTLY FABRICATED, DAMAGED, OR OTHERWISE MISFITTING OR NONCONFORMING MATERIALS OR CONDITIONS SHALL BE REPORTED TO THE OWNER PRIOR TO REMEDIAL OR CORRECTIVE ACTION. ANY SUCH REMEDIAL ACTION SHALL REQUIRE WRITTEN APPROVAL BY THE OWNER'S REPRESENTATIVE PRIOR TO PROCEEDING.
- 11. EACH CONTRACTOR SHALL COOPERATE WITH THE OWNER'S REPRESENTATIVE, AND COORDINATE HIS WORK WITH THE WORK OF OTHERS.
- 12. CONTRACTOR SHALL REPAIR ANY DAMAGE CAUSED BY CONSTRUCTION OF THIS PROJECT TO MATCH EXISTING PRE-CONSTRUCTION CONDITIONS TO THE SATISFACTION OF THE AT&T & CONSTRUCTION MANAGEDS
- 13. ALL CABLE/CONDUIT ENTRY/EXIT PORTS SHALL BE WEATHERPROOFED DURING INSTALLATION USING A SHICONE SEALANT
- 14. WHERE EXISTING CONDITIONS DO NOT MATCH THOSE SHOWN IN THIS PLAN SET, CONTRACTOR WILL NOTIFY ENGINEER, AT&T PROJECT CONSTRUCTION MANAGER, AND LANDLORD IMMEDIATELY.
- 15. CONTRACTOR SHALL ENSURE ALL SUBCONTRACTORS ARE PROVIDED WITH A CURRENT SET OF DRAWINGS AND SPECIFICATIONS FOR THIS PROJECT.
- 16. CONTRACTOR SHALL REMOVE ALL RUBBISH AND DEBRIS FROM THE SITE AT THE END OF EACH DAY.
- 17. CONTRACTOR SHALL COORDINATE WORK SCHEDULE WITH LANDLORD AND TAKE PRECAUTIONS TO MINIMIZE IMPACT AND DISRUPTION OF OTHER OCCUPANTS OF THE FACILITY.
- 18. CONTRACTOR SHALL FURNISH AT&T WITH THREE AS-BUILT SETS OF DRAWINGS EACH UPON COMPLETION OF WORK.
- 19. ANTENNAS AND CABLES ARE TYPICALLY PROVIDED BY AT&T. PRIOR TO SUBMISSION OF BID, CONTRACTOR SHALL COORDINATE WITH AT&T PROJECT MANAGERS TO DETERMINE WHAT, IF ANY, ITEMS WILL BE PROVIDED BY AT&T. ALL ITEMS NOT PROVIDED BY AT&T SHALL BE PROVIDED AND INSTALLED BY THE CONTRACTOR. CONTRACTOR WILL INSTALL ALL ITEMS PROVIDED BY AT&T.
- 20. PRIOR TO SUBMISSION OF BID, CONTRACTOR WILL COORDINATE WITH AT&T PROJECT MANAGERS TO DETERMINE IF ANY PERMITS WILL BE OBTAINED BY AT&T. ALL REQUIRED PERMITS NOT OBTAINED BY AT&T MUST BE OBTAINED, AND PAID FOR, BY THE CONTRACTOR.
- 21. CONTRACTOR SHALL INSTALL ALL SITE SIGNAGE IN ACCORDANCE WITH AT&T SPECIFICATIONS AND REQUIREMENTS
- 22. CONTRACTOR SHALL SUBMIT ALL SHOP DRAWINGS TO ENGINEER FOR REVIEW AND APPROVAL PRIOR
- 23. UNLESS OTHERWISE NOTED AT&T SHALL PROVIDE ALL REQUIRED RF MATERIAL FOR CONTRACTOR TO INSTALL, INCLUDING ANTENNAS, TMA'S, RRH'S, BIAS—T'S, COMBINERS, PDU, DC BLOCKS, SURGE ARRESTORS. OVP'S. GPS ANTENNA. GPS SURGE ARRESTOR. COAXIAL CABLE.
- 24. PRIOR TO SUBMISSION OF BID, CONTRACTOR SHALL VERIFY ALL EQUIPMENT TO BE PROVIDED BY AT&T & FOR INSTALLATION BY CONTRACTOR
- 25. ALL EQUIPMENT SHALL BE INSTALLED ACCORDING TO MANUFACTURER'S SPECIFICATIONS AND LOCATED ACCORDING TO AT&T SPECIFICATIONS, AND AS SHOWN IN THESE PLANS.
- 26. THE CONTRACTOR SHALL SUPERVISE AND DIRECT THE PROJECT DESCRIBED HEREIN. THE CONTRACTOR SHALL BE SOLELY RESPONSIBLE FOR ALL THE CONSTRUCTION MEANS, METHODS, TECHNIQUES, SEQUENCES AND PROCEDURES AND FOR COORDINATING ALL PORTIONS OF THE WORK
- 27. CONTRACTOR SHALL NOTIFY DEWBERRY 48 HOURS IN ADVANCE OF POURING CONCRETE, OR BACKFILLING TRENCHES, SEALING ROOF AND WALL PENETRATIONS & POST DOWNS, FINISHING NEW WALLS OR FINAL ELECTRICAL CONNECTIONS FOR ENGINEER REVI
- 28. CONTRACTOR SHALL BE RESPONSIBLE FOR SITE SAFETY INCLUDING COMPLIANCE WITH ALL APPLICABLE OSHA STANDARDS AND RECOMMENDATIONS AND SHALL PROVIDE ALL NECESSARY SAFETY DEVICES INCLUDING PPE AND PPM AND CONSTRUCTION DEVICES SUCH AS WELDING AND FIRE PREVENTION, TEMPORARY SHORING, SCAFFOLDING, TRENCH BOXES/SLOPING, BARRIERS, ETC.
- 29. CONTRACTOR SHALL FOLLOW THE APPROVED WORK PLAN FOR THE SITE AND HAVE WORKERS THAT ARE OSHA APPROVED FOR ANY WORK WHICH INVOLVES THE SOIL OR GROUNDWATER.
- 30. ALL WORK TO BE COMPLETED BY CONTRACTOR UNLESS NOTED OTHERWISE.

#### **CONCRETE AND REINFORCING STEEL NOTES:**

- DESIGN AND CONSTRUCTION OF ALL CONCRETE ELEMENTS SHALL CONFORM TO THE LATEST EDITIONS
  OF ALL APPLICABLE CODES INCLUDING: ACI 301 "SPECIFICATIONS FOR STRUCTURAL CONCRETE FOR
  BUILDINGS", AND ACI 318 "BUILDING CODE REQUIREMENTS FOR REINFORCED CONCRETE".
- 2. MIX DESIGN SHALL BE APPROVED BY OWNER'S REPRESENTATIVE AND SUBMITTED TO ENGINEER PRIOR TO PLACING CONCRETE.
- CONCRETE SHALL BE NORMAL WEIGHT, 6 % AIR ENTRAINED (+/- 1.5%) WITH A MAXIMUM 4" SLUMP AND HAVE A MINIMUM 28-DAY COMPRESSIVE STRENGTH OF 4000 PSI UNLESS OTHERWISE NOTED.
- 4. THE FOLLOWING MATERIALS SHALL BE USED:
  PORTLAND CEMENT: ASTM C-150, TYPE 1 OR 2
  REINFORCEMENT: ASTM A-185, PLAIN STEEL WELDED WIRE FABRIC
  REINFORCEMENT BARS: ASTM A615, GRADE 60, DEFORMED
  NORMAL WEIGHT AGGREGATE: ASTM C-33
  WATER: DRINKABLE
  ADMIXTURES: NON-CHLORIDE CONTAINING
- 5. MINIMUM CONCRETE COVER FOR REINFORCING STEEL SHALL BE AS FOLLOWS (UNLESS OTHERWISE NOTED):
- A. CONCRETE CAST AGAINST EARTH: 3"
- A 3/4" CHAMFER SHALL BE PROVIDED AT ALL EXPOSED EDGES OF CONCRETE IN ACCORDANCE WITH ACI 301 SECTION 4.2.4, UNLESS NOTED OTHERWISE.
- 7. INSTALLATION OF CONCRETE EXPANSION/WEDGE ANCHOR SHALL BE PER MANUFACTURER'S WRITTEN RECOMMENDED PROCEDURE. THE ANCHOR BOLT, DOWEL, OR ROD SHALL CONFORM TO MANUFACTURER'S RECOMMENDATION FOR EMBEDMENT DEPTH OR AS SHOWN ON THE DRAWINGS. NO REBAR SHALL BE CUT WITHOUT PRIOR ENGINEERING APPROVAL WHEN DRILLING HOLES IN CONCRETE.
- 8. ADMIXTURES SHALL CONFORM TO THE APPROPRIATE ASTM STANDARD AS REFERENCED IN ACL 301.
- 9. DO NOT WELD OR TACK WELD REINFORCING STEEL.
- 10. ALL DOWELS, ANCHOR BOLTS, EMBEDDED STEEL, ELECTRICAL CONDUITS, PIPE SLEEVES, GROUNDS AND ALL OTHER EMBEDDED ITEMS AND FORMED DETAILS SHALL BE IN PLACE BEFORE START OF CONCRETE PLACEMENT.
- 11. REINFORCEMENT SHALL BE COLD BENT WHENEVER BENDING IS REQUIRED.
- 12. DO NOT PLACE CONCRETE IN WATER, ICE, OR ON FROZEN GROUND.
- 13. DO NOT ALLOW REINFORCEMENT, CONCRETE OR SUBBASE TO FREEZE DURING CONCRETE CURING AND SETTING PERIOD, OR FOR A MINIMUM OF 3 DAYS AFTER PLACEMENT.
- 14. FOR COLD—WEATHER AND HOT—WEATHER CONCRETE PLACEMENT, CONFORM TO APPLICABLE ACI CODES AND RECOMMENDATIONS. IN EITHER CASE, MATERIALS CONTAINING CHLORIDE, CALCIUM, SALTS, ETC. SHALL NOT BE USED. PROTECT FRESH CONCRETE FROM WEATHER FOR 7 DAYS, MINIMUM.
- 15. CONCRETE SHALL BE RUBBED TO A ROUGH GROUT FINISH. PADS SHALL BE SEALED BY STEEL TROWEL.
- 16. UNLESS OTHERWISE NOTED:
  - A. ALL REINFORCING STEEL SHALL BE DEFORMED BARS CONFORMING TO ASTM A615, GRADE 60.
- B. WELDED WIRE FABRIC SHALL CONFORM TO ASTM A185.
- 17. SPLICING OF REINFORCEMENT IS PERMITTED ONLY AT LOCATIONS SHOWN IN THE CONTRACT DRAWINGS OR AS ACCEPTED BY THE ENGINEER. UNLESS OTHERWISE SHOWN OR NOTED REINFORCING STEEL SHALL BE SPLICED TO DEVELOP ITS FULL TENSILE CAPACITY (CLASS A) IN ACCORDANCE WITH ACI 318.
- 18. REINFORCING BAR DEVELOPMENT LENGTHS, AS COMPUTED IN ACCORDANCE WITH ACI 318, FORM THE BASIS FOR BAR EMBEDMENT LENGTHS AND BAR SPLICED LENGTHS SHOWN IN THE DRAWINGS. APPLY APPROPRIATE MODIFICATION FACTORS FOR TOP STEEL, BAR SPACING, COVER AND THE LIKE.
- DETAILING OF REINFORCING STEEL SHALL CONFORM TO "ACI MANUAL OF STANDARD PRACTICE FOR DETAILING REINFORCED CONCRETE STRUCTURES" (ACI 315).
- 20. ALL SLAB CONSTRUCTION SHALL BE CAST MONOLITHICALLY WITHOUT HORIZONTAL CONSTRUCTION JOINTS, UNLESS SHOWN IN THE CONTRACT DRAWINGS.
- 21. LOCATION OF ALL CONSTRUCTION JOINTS ARE SUBJECT TO THE REQUIREMENTS OF THE CONTRACT DOCUMENTS, CONFORMANCE WITH ACI 318, AND ACCEPTANCE OF THE ENGINEER. DRAWINGS SHOWING LOCATION OF DETAILS OF THE PROPOSED CONSTRUCTION JOINTS SHALL BE SUBMITTED WITH REINFORCING STEEL PLACEMENT DRAWINGS
- 22. SPLICES OF WWF, AT ALL SPLICED EDGES, SHALL BE SUCH THAT THE OVERLAP MEASURED BETWEEN OUTERMOST CROSS WIRES OF EACH FABRIC SHEET IS NOT LESS THAN THE SPACING OF THE CROSS WIRE PLUS 2 INCHES, NOR LESS THAN 8".
- 23. BAR SUPPORTS SHALL BE ALL-GALVANIZED METAL WITH PLASTIC TIPS.
- 24. ALL REINFORCEMENT SHALL BE SECURELY TIED IN PLACE TO PREVENT DISPLACEMENT BY CONSTRUCTION TRAFFIC OR CONCRETE. TIE WIRE SHALL BE 16 GAUGE CONFORMING TO ASTM A82
- 5. SLAB ON GROUND
- A. COMPACT STRUCTURAL FILL TO 95% DENSITY AND THEN PLACE 6" GRAVEL BENEATH SLAB.
- B. PROVIDE VAPOR BARRIER BENEATH SLAB ON GROUND.

### **STRUCTURAL NOTES:**

- 1. AS REQUIRED UNDER THE STRUCTURAL STANDARD FOR ANTENNA SUPPORTING STRUCTURES AND ANTENNA, TIA/EIA-222-G, AT&T SHALL PROVIDE A STRUCTURAL ANALYSIS OF THE TOWER PREPARED BY A LICENSED NEW JERSEY STRUCTURAL ENGINEER CERTIFYING THAT THE EXISTING TOWER AND ANY REQUIRED IMPROVEMENTS AND REINFORCEMENTS HAVE SUFFICIENT CAPACITY TO SUPPORT ALL EXISTING AND PROPOSED ANTENNAS, SUPPORTS AND APPURTENANCES AND COMPLIES WITH THE CURRENT NEW YORK STATE BUILDING CODE AND EIA/TIA CRITERIA. THE CONTRACTOR IS RESPONSIBLE TO CONFIRM THAT ANY IMPROVEMENTS AND REINFORCEMENTS REQUIRED BY THE STRUCTURAL ANALYSIS CERTIFICATION ARE PROPERLY INSTALLED PRIOR TO THE ADDITION OF ANTENNAS, SUPPORTS AND APPURTENANCES PROPOSED ON THESE DRAWINGS OR OTHERWISE NOTED IN THE STRUCTURAL ANALYSIS.
- FOR STRUCTURAL MODIFICATIONS REQUIRING FIELD WELDING; THE CONTRACTOR IS RESPONSIBLE FOR OBTAINING ALL REQUIRED PERMITS AND IMPLEMENTING ALL INDUSTRY STANDARDS FOR PROTECTION OF ALL EXISTING PROPERTY AND PERSONNEL FOR DAMAGE OR HARM. ALL PROPERTY DAMAGED DURING CONSTRUCTION OF THIS PROJECT SHALL BE REPLACED OR REPAIRED TO THE SATISFACTION OF THE OWNER.



New Cingular Wireless PCS, LLC One AT&T Way Bedminster, NJ 07921



WICKATUNK FA#: 14209075 SITE#: NWL00575

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Dewberry Engineers Inc.

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DAVID E. REVETTE NJ LICENSE No. 24GE05408600

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DRAWN BY: JC

REVIEWED BY: GHN

CHECKED BY: GHN

PROJECT NUMBER: 50110598

JOB NUMBER: 50110612

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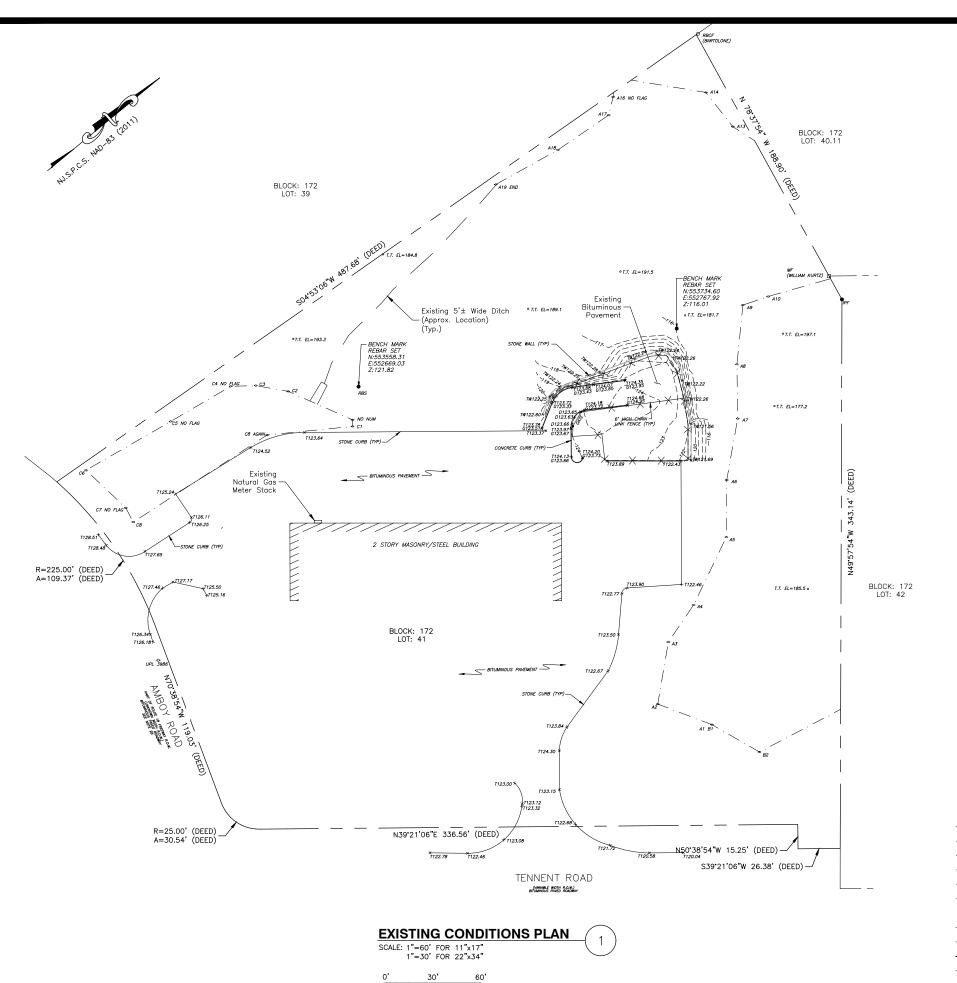
316 TENNENT ROAD MORGANVILLE, NJ 0775 MARLBORO TOWNSHIP

SHEET TITLE

GENERAL NOTES

SHEET NUMBER

G - 1



#### NOTES:

- THIS PLAN WAS PREPARED WITHOUT THE BENEFIT OF A TITLE REPORT AND IS SUBJECT TO ANY EASEMENT, RESTRICTION AND/OR COVENANTS THAT A CURRENT REPORT OF TITLE, OR COMPLETE SEARCH OF THE PUBLIC RECORD, MAY DISCLOSE.
- 2. THIS SURVEY WAS PREPARED IN ACCORDANCE WITH THE FOLLOWING SOURCES OF INFORMATION  $% \left( 1\right) =\left( 1\right) \left( 1$ 
  - A -DEEDS OF RECORD
  - B -PLAN OF "MAJOR SUBDIVISION" PREPARED BY CREST ENGINEERING ASSOCIATES INC. FILED IN MONMOUTH COUNTY CLERKS OFFICE ON SEPTEMBER 10, 2001.
  - C -AN ACTUAL FIELD SURVEY PERFORMED BY DEWBERRY ENGINEERS
  - D —THE "NATIONAL FLOOD INSURANCE PROGRAM, FIRM, FLOOD INSURANCE RATE MAP, TOWNSHIP OF MARLBORO, NEW JERSEY, MONMOUTH COUNTY, PANEL 135 OF 457," COMMUNITY PANEL NUMBER 0135F, EFFECTIVE DATE: SEPTEMBER 25, 2009, PARCEL IS LOCATED IN SPECIAL FLOOD HAZARD ZONE X (AREAS DETERMINED TO BE OUTSIDE THE 0.2% ANNUAL CHANCE FLOODPLAIN).
- BLOCK AND LOT NUMBERS REFER TO THE OFFICIAL TAX MAPS OF THE TOWNSHIP OF MARLBORO, MONMOUTH COUNTY, NEW JERSEY, SHEET #56.
- PLANIMETRIC & TOPOGRAPHIC FEATURES SHOWN ARE TAKEN FROM AN ACTUAL FIELD SURVEY PERFORMED BY DEWBERRY ENGINEERS INC. ON NOVEMBER 11, 2019.
- 5. THIS PLAN IS NOT INTENDED TO GUARANTEE OWNERSHIP.
- 6. SURVEY BASED ON N.J.S.P.C.S. NAD '83 (2011).
- 7. IT IS BEYOND THE SCOPE OF THIS PLAN TO DETERMINE THE EXISTENCE OR NON-EXISTENCE OF ANY REGULATED ENVIRONMENTAL CONDITION ON OR NEAR THE SUBJECT PARCEL(S). UNDERGROUND EXPLORATIONS WERE NOT CONDUCTED OR UTILIZED DURING THE PREPARATION OF THIS PLAN. CONCERNED PARTIES SHOULD PURSUE ANY ENVIRONMENTAL MATTERS SEPARATE AND APART FROM THIS SURVEY.
- IT SHOULD NOT BE ASSUMED THAT ANY COPY OF THIS DRAWING WITHOUT A
  RAISED IMPRESSION OF THE SURVEYOR'S SEAL IS A TRUE COPY OF THE ORIGINAL
  AS ISSUED BY THE SURVEYOR.
- 9. THE LOCATION OF UNDERGROUND UTILITIES ARE APPROXIMATE. ALL LOCATIONS ILLUSTRATED ARE BASED UPON UTILITY MARKOUT AND ABOVE GROUND STRUCTURES THAT WERE VISIBLE & ACCESSIBLE IN THE FIELD. THE STATE OF NEW JERSEY REQUIRES NOTIFICATION PRIOR TO ANY EXCAVATION BY UTILIZING THE NEW JERSEY ONE—CALL SYSTEM (1—800—272—1000).
- 10. THE WETLANDS SHOWN HEREON WERE DELINEATED BY DEWBERRY ENGINEERING INC ON 11/04/2019, REPORT DATED: 11/04/2019, AND FIELD LOCATED BY DEWBERRY ENGINEERS INC. ON 11/11/2019. NO SOIL BORING FLAGS WERE FOUND AT THE TIME OF FIELD SURVEY.
- 11. THE PURPOSE OF THIS PLAN IS TO ILLUSTRATE EXISTING TOPOGRAPHIC AND PLANIMETRIC FEATURES. IT IS BEYOND THE SCOPE OF THIS PLAN TO MAKE DETERMINATIONS ABOUT THE ACTUAL LOCATION OF RIGHT OF WAY AND PROPERTY LINES.

## **LEGEND**

THESE STANDARD ABBREVIATIONS, ACRONYMS, HATCHES, LINETYPES AND SYMBOLS WILL BE FOUND IN THE DRAWING:

PERVIOUS ELEVATION
IMPERVIOUS ELEVATION
612.34 × GUTTER ELEVATION
712.34 × TOP OF CURB ELEVATION
012.34 × TOP OF DEPRESSED CURB ELEVATION
71. EL-12.3 × TOP OF TREE ELEVATION
11. EL

//////	BUILDING
	PROPERTY LINE - PIQ
	BUILDING
	CONTOUR
	CONTOUR - INDEX
	CURB
	DITCH
•	FENCE - GATE
x x x x x	FENCE - STEEL (CHAIN LINK, WIRE,
	EDGE OF PAVEMENT
	WALL

— — — — WETLANDS



New Cingular Wireless PCS, LLC One AT&T Way Bedminster, NJ 07921



WICKATUNK FA#: 14209075 SITE#: NWL00575

	ZONING DRAWINGS						
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С		ISSUED FOR REVIEW					
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316 TENNENT ROAD MORGANVILLE, NJ 07751 MARLBORO TOWNSHIP


SHEET TITLE

ETC.)

EXISTING CONDITIONS PLAN & NOTES

SHEET NUMBER

7—

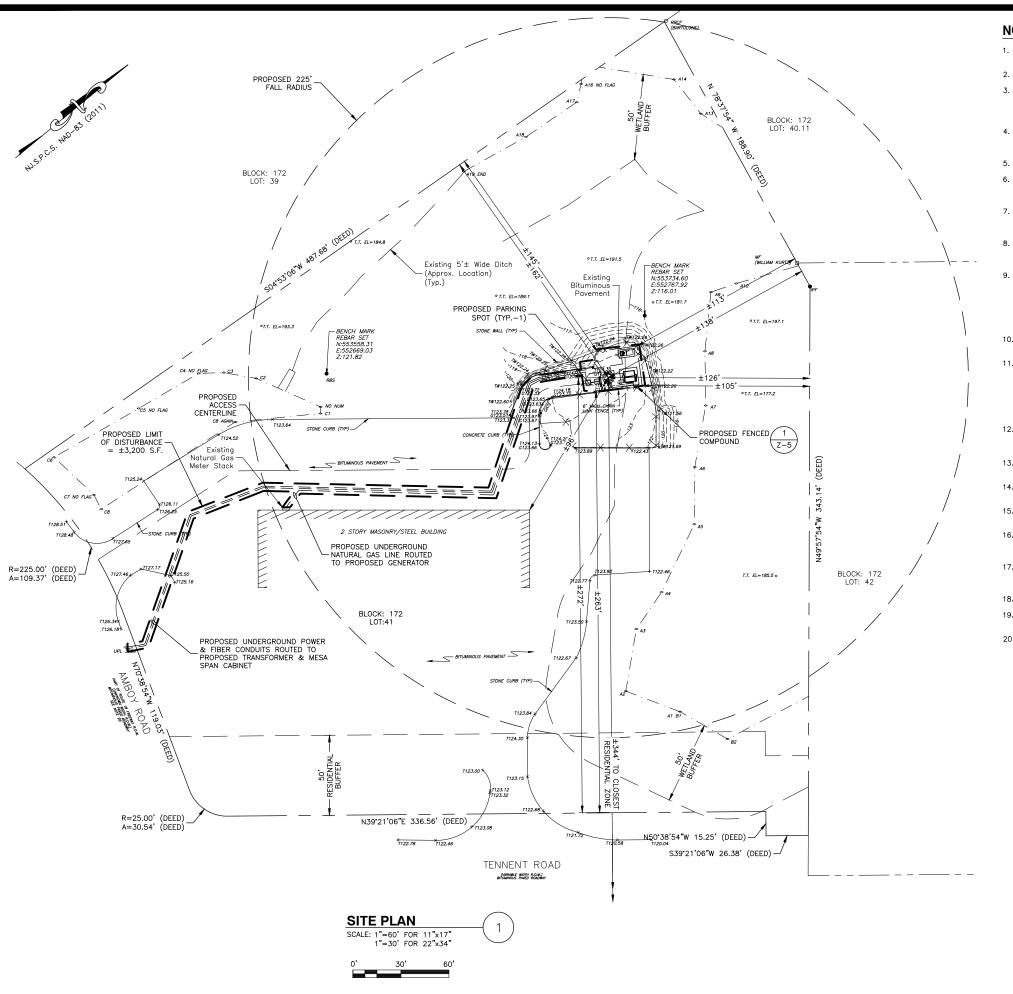

- SUBJECT PROPERTIES ARE KNOWN AS BLOCK 172, LOT 41 AS SHOWN ON THE OFFICIAL TAX ASSESSMENT MAP OF THE TOWNSHIP OF MARLBORO, SHEET 48.
- 2. ZONING CLASSIFICATION: IOR: INDUSTRIAL-OFFICE-RESEARCH

APPLICANT:

AT&T MOBLITY

NEW CINGULAR WIRELESS PCS, LLC ("AT&T") 1 AT&T WAY

BEDMINSTER, NJ 07921

AMBTEN ROAD ASSOCIATES, LLC. 4. PROPERTY OWNER:

44 NIKKI COURT MORGANVILLE, NJ 07751

- 5. SUBJECT TO THE FINDINGS OF A TITLE SEARCH AND SURVEY.
- THIS PLAN IS NOT INTENDED TO DELINEATE OR DEFINE UNDERGROUND UTILITIES. THE USER IS CAUTIONED TO CONTACT NEW JERSEY ONE CALL FOR UTILITY MARKOUTS AT 1-800-272-1000.
- THE PROPOSED USE IS FOR TELECOMMUNICATIONS AND IS NOT INTENDED FOR PERMANENT EMPLOYEE OCCUPANCY. THEREFORE, POTABLE WATER, SANITARY SEWERS, AND ADDITIONAL ON SITE PARKING ARE NOT REQUIRED.
- THE FACILITY SHALL BE VISITED ON THE AVERAGE OF ONCE A MONTH FOR MAINTENANCE AND SHALL BE CONTINUOUSLY MONITORED FROM A REMOTE FACILITY FOR BOTH FIRE AND INTRUSION.
- THE FACILITIES ARE REMOTELY OPERATED AND CONTROLLED, AND AS SUCH, ARE NORMALLY UNMANNED. A COMPUTERIZED EQUIPMENT AND FACILITY ALARM SYSTEM CONTINUOUSLY MONITORS AN EXTENSIVE NUMBER OF OPERATING AND BUILDING FUNCTIONS. UNPLANNED EVENTS WILL TRIGGER ALARM REPORTS TO VERIZON WIRELESS HEADQUARTERS LOCATION IN BEDMINSTER, NJ, RANGING FROM ROUTINE REPORTS TO IMMEDIATE ACTIVATION OF LOCAL PERSONNEL OR EMERGENCY
- 10. A MANUALLY ACTUATED LED WALL PACK LIGHT WITH TIMER IS ATTACHED TO THE EQUIPMENT SHELTER TO PROVIDE AREA LIGHTING DURING MAINTENANCE ONLY.
- 11. ALL MATERIALS, WORKMANSHIP AND CONSTRUCTION FOR THE SITE IMPROVEMENTS SHOWN HEREIN SHALL BE IN ACCORDANCE WITH:
  - 11.1. CURRENT PREVAILING MUNICIPAL AND/OR STATE SPECIFICATIONS, STANDARDS
  - AND REQUIREMENTS.

    11.2. CURRENT PREVAILING UTILITY COMPANY AUTHORITY SPECIFICATIONS, STANDARDS AND REQUIREMENTS.
- CONTRACTOR SHALL CONTACT "GARDEN STATE UNDERGROUND PLANT LOCATION SERVICE" AT 1-800-272-1000 AND LOCATE ALL EXISTING UTILITIES WITHIN THE AREA OF WORK PRIOR TO START OF EXCAVATION.
- 13. CONTRACTOR SHALL COORDINATE & COMPLY WITH EXISTING UTILITY COMPANIES'
- 14. THERE ARE NO PROPOSED ALTERATIONS, IMPROVEMENTS OR RELOCATIONS FOR ANY STREAMS OR EXISTING DRAINAGE STRUCTURES WITHIN THE PROPERTY.
- 15. BASED ON THE NATIONAL WETLANDS INVENTORY MAPS FOR NEW JERSEY, MARLBORO TOWNSHIP NJ QUADRANGLE MAP, WETLANDS ARE NOT PRESENT ON THE SITE.
- 16. THESE DRAWINGS ARE PROVIDED FOR ZONING APPROVAL. CONSTRUCTION LEVEL DRAWINGS WILL BE DEVELOPED SUBSEQUENT TO THE APPROVAL OF THESE
- 17. BEFORE CONSTRUCTION A STRUCTURAL ANALYSIS OF TOWER WILL BE PERFORMED. A COPY OF THE STRUCTURAL ANALYSIS WILL BE SUBMITTED TO THE TOWNSHIP FOR REVIEW WHEN A BUILDING PERMIT APPLICATION IS SUBMITTED.
- 18. NO LANDSCAPING IS PROPOSED AT THIS FACILITY
- A SOIL EROSION AND SEDIMENT CONTROL CERTIFICATION WILL NOT BE REQUIRED SINCE THERE IS LESS THAN 5,000 S.F. DISTURBANCE.
- 20. NO TREES ARE TO BE REMOVED UNDER THIS SUBMITTAL.



New Cingular Wireless PCS, LLC One AT&T Way Bedminster, NJ 07921



**WICKATUNK** FA#: 14209075 SITE#: NWL00575

	ZONING DRAWINGS						
1		ISSUED FOR ZONING					
0	04/22/20	ISSUED FOR ZONING					
С		ISSUED FOR REVIEW					
В	03/04/20	ISSUED FOR REVIEW					
Α	01/29/20	ISSUED FOR REVIEW					



Dewberry Engineers Inc.

SUITE 301 PARSIPPANY, NJ 07054 PHONE: 973.739.9400 FAX: 973.739.9710 COA 24GA28047600



DAVID E. REVETTE NJ LICENSE No. 24GE05408600

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DRAWN BY:	JC
REVIEWED BY:	GHN
CHECKED BY:	GHN
PROJECT NUMBER:	50110598
JOB NUMBER:	50110612
SITE ADDRESS:	
740 75111517	
316 TENNENT	


MARLBORO TOWNSHIP


SHEET TITLE

SITE PLAN & NOTES

SHEET NUMBER

Z-2

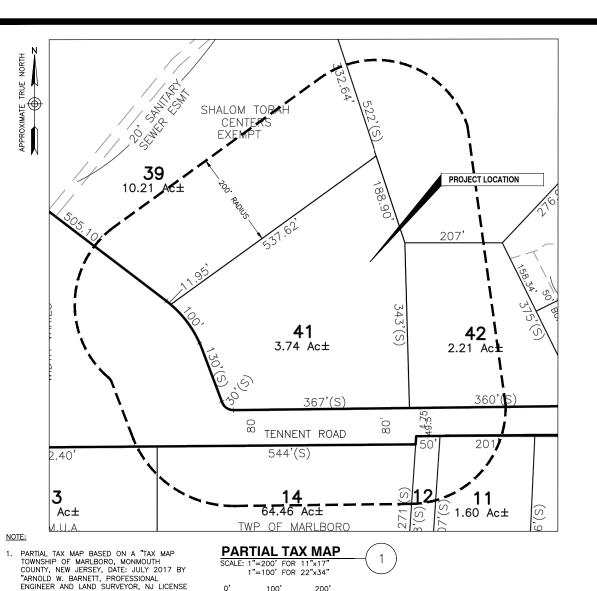

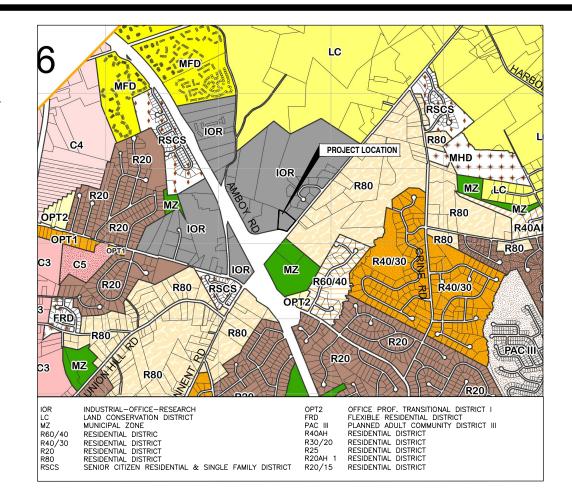

PARTIAL ZONING MAP

NOTE:

 PARTIAL ZONING MAP BASED ON THE ZONING MAP, TOWNSHIP OF MARLBORO, ENGINEERING DEPARTMENT GEOGRAPHIC INFORMATION SYSTEM, LAST REVISED

WIRELESS ORDINANCE REQUIREMENTS					
DESCRIPTION	REQUIRED	EXISTING	PROPOSED	REMARKS	
MINIMUM LOT AREA	5 ACRES	3.8 ACRES±	N/A	NON-CONFORMING	
TOWER STYLE	NO GUYED /LATTICE	N/A	MONOPINE	CONFORMING	
CARRIER NUMBER	3	N/A	3	CONFORMING	
MAXIMUM TOWER HEIGHT	150 FT	N/A	150 FT	CONFORMING	

#### STORMWATER MANAGEMENT

DUE TO THE RELATIVELY SMALL SIZE OF THE PROPOSED FACILITY, THERE WILL BE A MINIMAL IMPACT TO DRAINAGE CONDITIONS AT THE SITE.

200'

VARIAN	ICES REQUESTED

1. D-3 USE VARIANCE

No 14987".

## **WAIVERS REQUESTED**

LANDSCAPING BUFFER

TOWER SET BACK TOWER RESIDENTIAL SETBACK

ZONE DEVELOPMENT STANDARDS FOR IOR: INDUSTRIAL-OFFICE-RESEARCH				
DESCRIPTION	REQUIRED	EXISTING	PROPOSED	REMARKS
LOT:				
MIN. LOT AREA MIN. LOT WIDTH MIN. LOT DEPTH MIN. LOT FRONTAGE	5 ACRES 300 FEET 300 FEET 300 FEET	3.8 ACRES± 399.4 FEET± 367.8 FEET± 4545.3 FEET±	N/A N/A N/A N/A	NON-CONFORMING CONFORMING CONFORMING CONFORMING
TOWER SETBACKS (SEE NOTE 1):  MIN. FRONT YARD  MIN. SIDE YARD  MIN. REAR YARD	80 FEET 70 FEET 80 FEET	N/A N/A N/A	263 FEET± 126 FEET± 162 FEET±	CONFORMING CONFORMING CONFORMING
AT&T EQUIPMENT SHELTER SETBACKS:				
MIN. FRONT YARD MIN. SIDE YARD MIN. REAR YARD MAX. BUILDING COVERAGE MAX. FAR	80 FEET 50 FEET 60 FEET 35% 0.35	N/A N/A N/A N/A	263 FEET± 105 FEET± 145 FEET± 4%± .04±	CONFORMING CONFORMING CONFORMING CONFORMING CONFORMING
MAXIMUM HEIGHT: TOWER EQUIPMENT SHELTER	150 FEET 10 FEET	N/A N/A	150'-0" 9'-5"	CONFORMING CONFORMING
LOT COVERAGE: MAX. LOT COVERAGE	60%	10%	N/A	NON-CONFORMING

WIRELESS ORDINANCE DESIGN STANDARDS					
DESCRIPTION	REQUIRED	EXISTING	PROPOSED	REMARKS	
MINIMUM TOWER RESIDENTIAL SETBACK	500 FT	N/A	344'	WAIVER REQUESTED	
MINIMUM TOWER LOT LINE/BUILDING SETBACK	150% OF THE HEIGHT OF THE TOWER	N/A	126'	WAIVER REQUESTED	
FENCE HEIGHT	8 FT. W/ ANTI-CLIMBING	N/A	8 FT. W/ ANTI-CLIMBING	CONFORMING	
MINIMUM LANDSCAPE BUFFER	8 FT	N/A	0 FT	WAIVER REQUESTED	
MAXIMUM EQUIPMENT AREA	200 S.F.	N/A	17.3 S.F.	CONFORMING	
MAXIMUM EQUIPMENT HEIGHT	10 FT	N/A	9'-5" FT	CONFORMING	
MAXIMUM EQUIPMENT BUILDING	1 PER CARRIER	N/A	1	CONFORMING	
MINIMUM EQUIPMENT SETBACKS (PER ZONE)		N/A	SEE ADJACENT BULK TABLE	CONFORMING	
FACILITY DESIGNED TO REDUCE VISUAL OBTRUSIVENESS	-	N/A	-	CONFORMING	
LIGHTING	EQUIPMENT	N/A	EQUIPMENT	CONFORMING	
ONLY SAFETY PERMITTED	-	N/A	-	CONFORMING	

- 1. TOWER SETBACK DIMENSIONS ARE TO OUTSIDE EDGE OF PROPOSED ANTENNAS.
- 2. REQUIREMENTS PER SECTION § 220-89 & § 220-162 OF THE MARLBORO



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JC
GHN
GHN
50110598
50110612

316 TENNENT ROAD MORGANVILLE, NJ 07751 MARLBORO TOWNSHIP

SHEET TITLE

SITE ADDRESS:

ZONING INFORMATION

SHEET NUMBER

	200' RADIUS PROPERTY OWNER'S LIST						
MUNICIPAL CODE	BLOCK	LOT	PROPERTY LOCATION	OWNER NAME	OWNER ADDRESS	CITY STATE	ZIP CODE
-	172	40.06	COMMERCIAL COURT	TRIPLE SEVEN HOLDINGS LLC	202 COMMERCIAL COURT	MORGANVILLE, NJ	07751
_	172	40.11	80 AMBOY ROAD	LUCAS BROTHERS, INC	80 AMBOY ROAD	MORGANVILLE, NJ	07751
_	172	39	70 AMBOY ROAD	SHALOM TORAH CENTERS	152 JAMES STREET	LAKEWOOD, NJ	08701
_	172	42	312 TENNENT ROAD	LAND BARON, LLC	308 TENNENT ROAD	MORGANVILLE, NJ	07751
_	180	14	ROUTE 520	TWP OF MARLBORO	1979 TOWNSHIP DRIVE	MARLBORO, NJ	07746
_	180	12	321 TENNENT ROAD	TENNENT ROAD HOLDINGS, LLC	161 WOODLAND MANOR	TINTON FALL, NJ	07724
_	180	13	337 TENNENT ROAD	TWP OF MARLBORO-MUN UTILITIES AUTH	1979 TOWNSHIP DRIVE	MARLBORO, NJ	07746
_	180	11	319 TENNENT ROAD	INGHAM, ALEXANDER & LAWSON, NADINE	319 TENNENT ROAD	MORGANVILLE, NJ	07751

UTILITY COMPANY NAMES			
W.M.U.A.	103 PENSION ROAD ENGLISHTOWN, NJ 07726		
MARLBORO TOWNSHIP WATER UTILITY	1979 TOWNSHIP DRIVE MARLBORO, NJ 07746		
GORDONS CORNER WATER UTILITY	27 VANDERBURG ROAD MARLBORO, NJ 07746		
N.J. NATURAL GAS COMPANY	1415 WYCOFF ROAD WALL, NJ 07719		
CABLEVISION OF MONMOUTH	40 PINE STREET TINTON FALLS, NJ 07753		
VERIZON NEW JERSEY INC	789 WAYSIDE ROAD NEPTUNE, NJ 07753		
JERSEY CENTRAL POWER AND LIGHT COMPANY	331 NEWMAN SPRINGS ROAD STE 325 BLDG 3 RED BANK, NJ 07701		
MONMOUTH COUNTY DEPARTMENT OF TRANSPORTATION	CENTER STREET & KOZLOWSKI ROAD FREEHOLD, NJ 07728		

PROPERTY OWNERS LIST



New Cingular Wireless PCS, LLC One AT&T Way Bedminster, NJ 07921



WICKATUNK FA#: 14209075 SITE#: NWL00575

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С	04/06/20	ISSUED FOR REVIEW
В		ISSUED FOR REVIEW
Α	01/29/20	ISSUED FOR REVIEW



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REVIEWED BY:	GHN
CHECKED BY:	GHN
PROJECT NUMBER:	50110598
JOB NUMBER:	50110612

JOB NUMBER: 501106

SITE ADDRESS:


DRAWN BY:

316 TENNENT ROAD MORGANVILLE, NJ 07751 MARLBORO TOWNSHIP

SHEET TITLE

LIST OF PROPERTY OWNERS

SHEET NUMBER

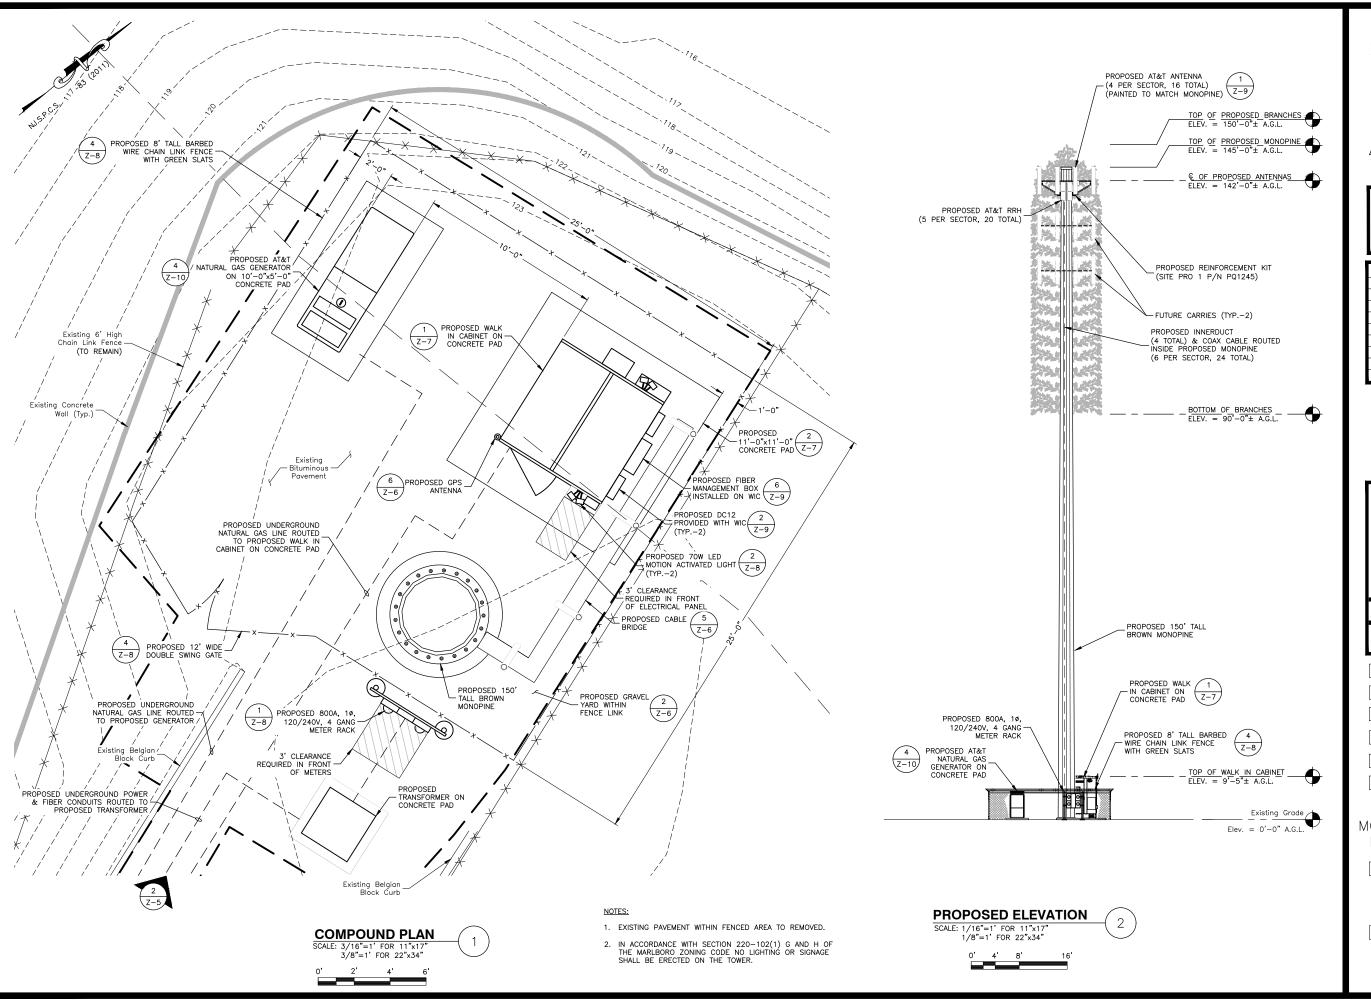



New Cingular Wireless PCS, LLC One AT&T Way Bedminster, NJ 07921



WICKATUNK FA#: 14209075 SITE#: NWL00575

	ZON	NING DRAWINGS
1	06/25/20	ISSUED FOR ZONING
0	04/22/20	ISSUED FOR ZONING
С	04/06/20	ISSUED FOR REVIEW
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PROJECT NUMBER:	50110598
JOB NUMBER:	50110612
SITE ADDRESS:	
316 TENNENT	ROAD


MORGANVILLE, NJ 07751 MARLBORO TOWNSHIP

SHEET TITLE

COMPOUND PLAN & ELEVATION

SHEET NUMBER

7 - 5

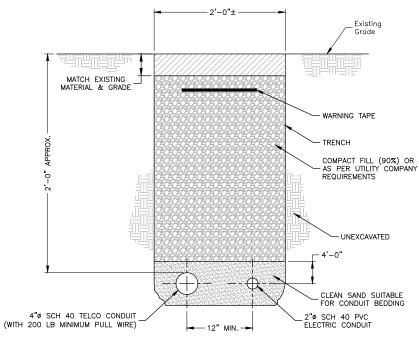


#### TRENCH NOTES:

- IF FREE OF ORGANIC OR OTHER DELETERIOUS MATERIAL, EXCAVATED MATERIAL MAY BE USED FOR BACKFILL.
- 2. IF NOT, PROVIDE CLEAN, COMPACTIBLE MATERIAL. COMPACT IN 8" LIFTS. REMOVE ANY LARGE ROCKS PRIOR TO BACKFILLING. CONTRACTOR TO VERIFY LOCATION OF EXISTING U/G UTILITIES PRIOR TO DIGGING.
- 3. IF CURRENT AS—BUILT DRAWINGS ARE NOT AVAILABLE, CONTRACTOR SHALL HAND DIG U/G TRENCHING.

# JOINT SERVICE TRENCH BURIED CONDUIT (ELECTRIC/TELEPHONE)


SCALE: N.T.S.


NOTES:

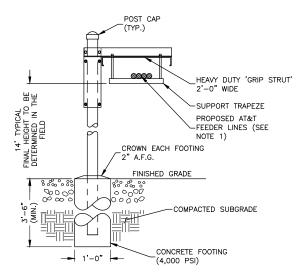


- CABLE BRIDGE SHALL BE SITE PRO 1 24" GRIP—SPAN ICE BRIDGE KIT WITH Z-BRACKET TRAPEZE P/N: IB24D-216Z FOR UP TO 14 LINES & P/N IB24D-216Z2 FOR 15-28 LINES OR APPROVED EQUAL.
- 2. ALL COMPONENTS SHALL BE INSTALLED ACCORDING TO MANUFACTURER'S SPECIFICATIONS.
- 3. CONTRACTOR SHALL DETERMINE REQUIRED QUANTITY OF ALL CABLE BRIDGE
- SNAP-IN HANGERS, SPLICE KITS, HINGE KITS, EXTENSION KITS, STIFFENERS, & OTHER MISCELLANEOUS HARDWARE SHALL BE PROVIDED BY THE CONTRACTOR AS REQUIRED.
- 5. CABLE BRIDGE SHALL BE ROUTED TO ACCOMMODATE THE MINIMUM BENDING RADIUS OF THE COAXIAL CABLE.
- 6. CABLE BRIDGE COMPONENTS SHOWN ARE SCHEMATIC, CONSULT MANUFACTURER FOR EXACT & CURRENT SPECIFICATIONS.

**CABLE BRIDGE DETAIL** 5

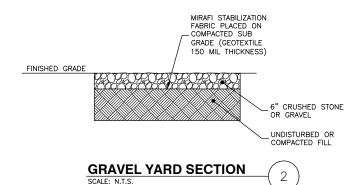

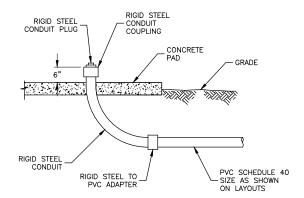


# UNDERGROUND CONDUIT STUB-UP DETAIL

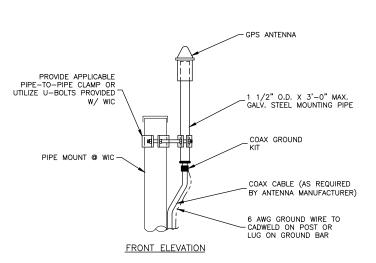

#### NOTES:

- LOCATION OF ANTENNA MUST HAVE CLEAR VIEW OF SOUTHERN SKY AND CANNOT HAVE ANY BLOCKAGES EXCEEDING 25% OF THE SURFACE AREA OF A HEMISPHERE AROUND THE GPS ANTENNA.
- 2. ALL GPS ANTENNA LOCATIONS <u>MUST BE</u> ABLE TO RECEIVE CLEAR SIGNALS FROM A MINIMUM OF FOUR (4) SATELLITES. VERIFY WITH HANDHELD GPS BEFORE FINAL LOCATION OF GPS ANTENNA.




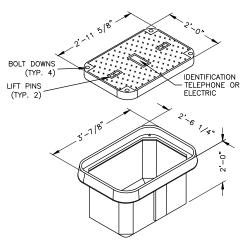

#### NOTE:

ALL STUB-UP CONDUITS INSIDE
 PULL BOXES WILL BE 6" FROM
 TOP OF BOX AND HAVE PULL
 STRING AND CAPS.



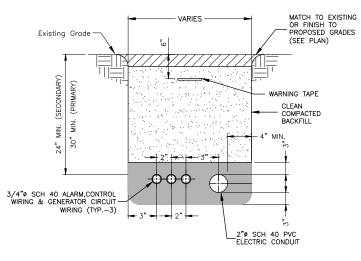

#### NOTES:

- IF FREE OF ORGANIC OR OTHER DELETERIOUS MATERIAL, EXCAVATED MATERIAL MAY BE USED FOR BACKFILL.
- . IF NOT, PROVIDE CLEAN, COMPACTIBLE MATERIAL. COMPACT IN 8" LIFTS. REMOVE ANY LARGE ROCKS PRIOR TO BACKFILLING. SUBCONTRACTOR TO VERIFY LOCATION OF EXISTING U/G UTILITIES PRIOR TO DIGGING.
- 3. IF CURRENT AS-BUILT DRAWINGS ARE NOT AVAILABLE SUBCONTRACTOR SHALL HAND DIG U/G TRENCHING.

#### **GENERATOR SERVICE TRENCH CONDUIT**


SCALE: N.T.S.



New Cingular Wireless PCS, LLC One AT&T Way Bedminster, NJ 07921



WICKATUNK FA#: 14209075 SITE#: NWL00575

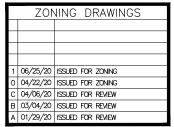



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 JC

 REVIEWED BY:
 GHN

 CHECKED BY:
 GHN

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SITE ADDRESS:


316 TENNENT ROAD MORGANVILLE, NJ 07751 MARLBORO TOWNSHIP

SHEET TITLE

CONSTRUCTION DETAILS I


SHEET NUMBER


7-6

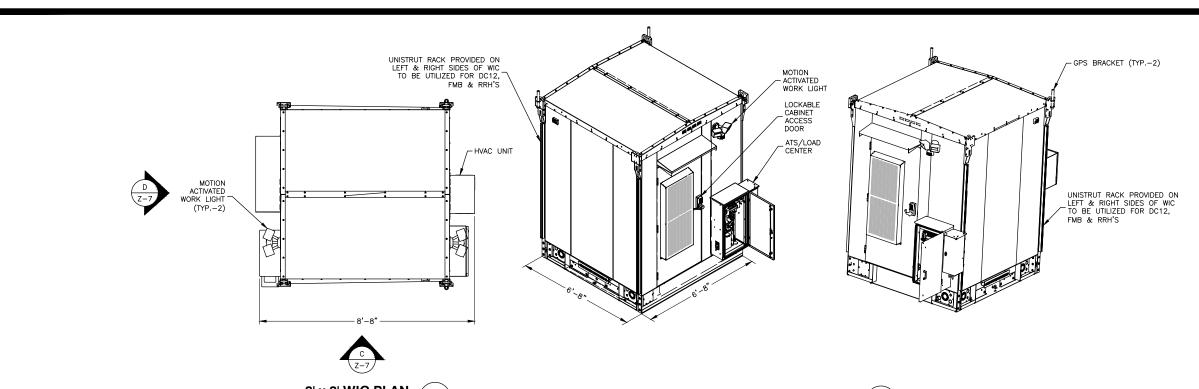

#### NOTES:

- WIC DETAIL BASED ON DRAWINGS BY VERTIV, DOCUMENT # AT&T WIC DESIGN LAYOUT DATED 03/01/17.
- ANCHOR WIC OR PLINTH W/ 1/2" HILTI KWIK BOLT 3 EXPANSION ANCHORS TO CONCRETE PAD.
- GALVANIZED P1000 TO BE UTILIZED AT WIC FOR DC12, FMB & RRH'S. CAP ENDS & INSTALL PER MANUFACTURER RECOMMENDATIONS.

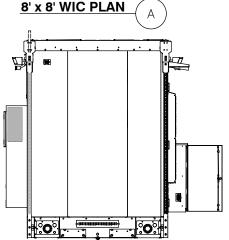

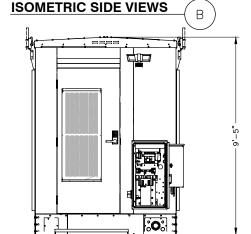

SHELTER FRONT ELEVATION

# SHELTER REAR ELEVATION **WIC SHELTER DETAIL** Z-7 CONCRETE PAD (SEE NOTE 2 BELOW) 6" COMPACTED GRAVEL -6" COMPACTED GRAVEL PREPARED SUBGRADE


# **SECTION**

USE	PAD LENGTH	PAD WIDTH
GENERATOR	10'-0"	5'-0"
CABINET	11'-0"	11'-0"

# CONCRETE PAD FOUNDATION

- CONTRACTOR TO VERIFY FINAL PAD DIMENSIONS PRIOR TO CONSTRUCTION OF
- 2. GRADE SHALL SLOPE AWAY FROM THE CONCRETE PAD TO ALLOW FOR PROPER
- ANCHOR EQUIPMENT TO FOUNDATION PER EQUIPMENT MANUFACTURER RECOMMENDATIONS.
- 4. IF BEDROCK IS ENCOUNTERED AT A SHALLOW DEPTH, USE DETAIL 4, THIS SHEET.
- 5. BEARING STRATA MEDIUM TO DENSE INSET GRANULAR MATERIAL OR COMPACTED GRAVEL FILL. 95% COMPACTION.
- 6. FILL SHALL CONSIST OF CLEAN SOIL. NO DELETERIOUS MATERIALS OR ORGANICS TO BE USED.
- 8. MAINTAIN 3" MIN. COVER ON ALL STEEL REINFORCEMENT.

7. CONCRETE SHALL HAVE A COMPRESSIVE STRENGTH OF 4,000 PSI.

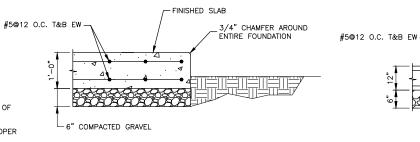



# FOUNDATION SLAB DETAIL @ BEDROCK

FINISHED SLAB

#4 DOWELS TO MATCH VERTICAL REINFORCEMENT

SCALE: N.T.S.



New Cingular Wireless PCS, LLC One AT&T Way Bedminster, NJ 07921 ROSMITH DEVELOPMENT

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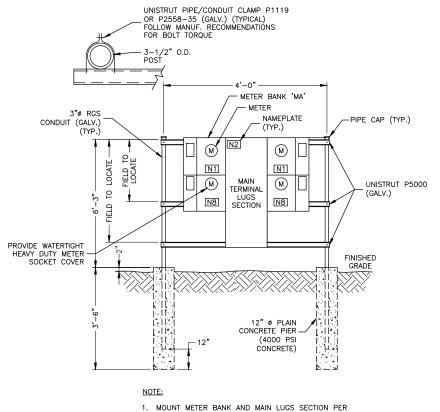
3/4" CHAMFER AROUND ENTIRE FOUNDATION

GROUT BAR 6" MIN.

INTO BEDROCK (TYP.)

CONSTRUCTION DETAILS II

SHEET NUMBER



SHOEBOX LIGHTING SHELTER -FIXTURE FT 2.0fc 1.0fc 0.5fc 21 14 7 0 7 14 21 28

ISO FOOT CANDLE PLOT WALL

FIXTURE MOUNTING HEIGHT 8'-0"

**MOUNTED-PAK 70W LIGHT** 

SCALE: N.T.S.

DC12 & FMB DETAIL SCALE: N.T.S.

DC12

0

3

 ALCATEL-LUCENT (ALU) VIA AT&T SUPPLIES THE RRH. CONTRACTOR SHALL SUPPLY ALL OTHER MATERIALS AND INSTALL ALL MOUNTING HARDWARE. ALU INSTALLS RRH AND MAKES CABLE TERMINATIONS.

2. MOUNT UNISTRUT TO 2-1/2"ø STD. PIPE WITH 1/2"

DC12

P1000 UNISTRUT CHANNEL

OR EQUIVALENT MOUNTED
TO EXISTING VERTICAL
UNISTRUT ON WIC (LENGTH

TO BE VERIFIED IN FIELD BY CONTRACTOR) (TYP.)

- 4. MOUNT RRH TO UNISTRUT WITH 3/8" UNISTRUT BOLTING HARDWARE AND SPRING NUTS. TYPICAL FOUR PER BRACKET. CONTRACTOR SHALL SUPPLY.
- 5. MOUNT FIBER AND POWER DISTRIBUTION BOX WITH FOUR (4) 1/4" UNISTRUT BOLTING HARDWARE AND SPRING NUTS.
- 6. NO PAINTING OF THE RRH OR SOLAR SHIELD ALLOWED.
- 7. SEE SITE PLAN FOR QUANTITY

FIRER


MANAGEMENT

#### **MULTIPLE POWER METER MOUNTING** SCALE: N.T.S.

10"ø CONCRETE

FOOTING IN SOIL FOR INTERMEDIATE POSTS

MANUFACTURER'S RECOMMENDATION AND INSTRUCTIONS.

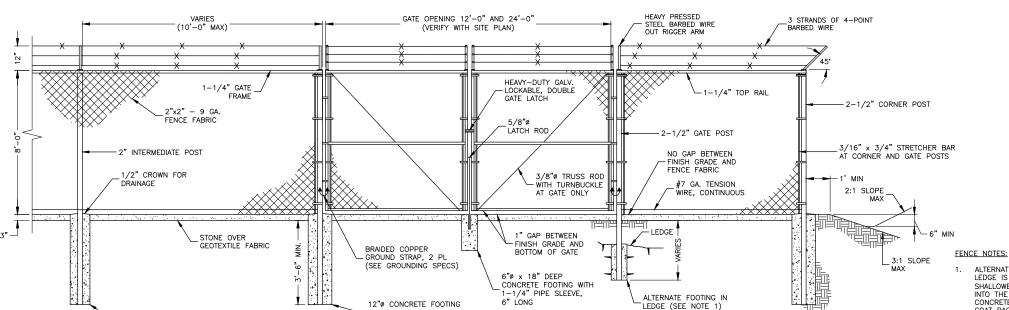

**FENCE AND ACCESS GATE** 

-IN SOIL FOR GATE AND CORNER POSTS

ALTERNATE FOOTINGS FOR ALL FENCE POSTS IN LEDGE: IF LEDGE IS ENCOUNTERED AT GRADE, OR AT A DEPTH SHALLOWER THAN 3'-6", CORE DRILL AN 8" DIA HOLE 18" INTO THE LEDGE. CENTER POST IN THE HOLE AND FILL WITH CONCRETE OR GROUT. IF LEDGE IS BELOW FINISH GRADE, COAT BACKFILLED SECTION OF POST WITH COAL TAR, AND RECEPTIVE WITH METH METH. DRANING COANCEL BACKFILL WITH WELL-DRAINING GRAVEL

- ATTACH EACH GATE WITH 1-1/2 PAIR OF NON-LIFT-OFF TYPE, MALLEABLE IRON OR FORGING, PIN-TYPE HINGES. ASSEMBLIES SHALL ALLOW FOR 180° OF GATE TRAVEL.
- INSTALL SWALE AROUND COMPOUND (MIN. DEPTH: 6") TO ALLOW FOR DRAINAGE.
- CONCRETE FOOTINGS SHALL HAVE A MINIMUM 28-DAY COMPRESSIVE STRENGTH OF 4000 PSI UNLESS OTHERWISE NOTED.
- 5. GREEN SLATS TO BE INSTALLED IN THE FENCING.



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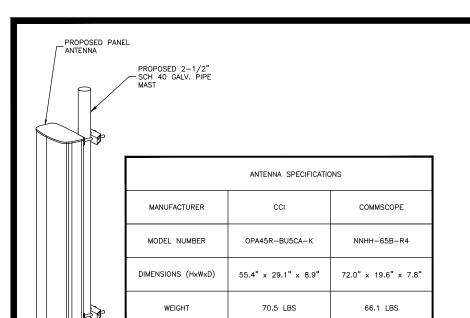
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T ROAD	316 TENNE
N.I 077	ORGANVILLE

MARLBORO TOWNSHIP


SHEET TITLE

CONSTRUCTION DETAILS III




#### NOTES:

- 1. MOUNT ANTENNA PER MANUFACTURER'S RECOMMENDATIONS.
- 2. WEIGHT DOES NOT INCLUDE MOUNTING BRACKETS.

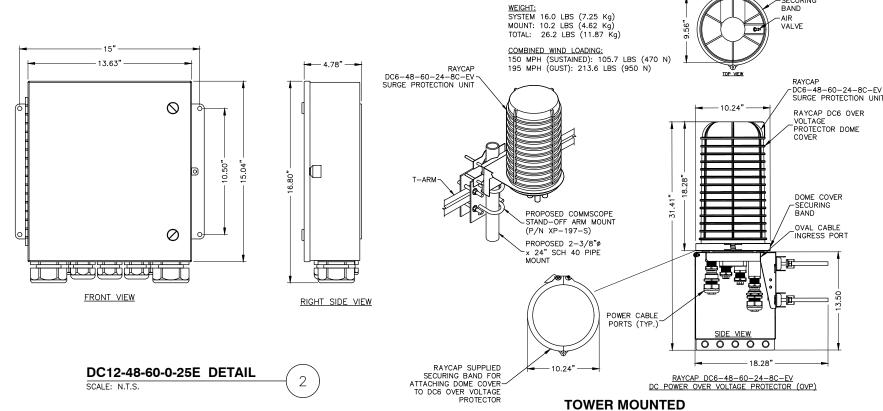





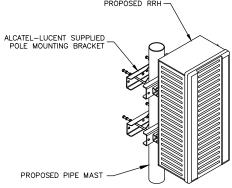

#### AT SECTOR


### NOTES:

- 1. MOUNT REMOTE RADIO HEAD PER MANUFACTURER'S RECOMMENDATIONS.
- 2. SIZES INCLUDE SOLAR SHIELD.
- CONTRACTOR TO VERIFY THAT PROPOSED RRH UNITS HAVE ADEQUATE CLEARANCE PER MANUFACTURER'S RECOMMENDATIONS. ADJUST SPACING ON UNISTRUT TO ACCOMMODATE.

RRH SPEC	CIFICATIONS	RRH SPECIFICATIONS	
MANUFACTURER	NOKIA	MANUFACTURER	NOKIA
MODEL NUMBER	AIRSCALE RRH4T4R B12/B14 320W (AHLBA)	MODEL NUMBER	AIRSCALE 4T4R B5
DIMENSIONS (HxWxD)	28.7" x 15.4" x 9.4"	DIMENSIONS (HxWxD)	13.3" x 11.6" x 6.5"
WEIGHT	101.2 LBS	WEIGHT	36.7 LBS
FIBER #	2	FIBER #	1

RRH SPECIFICATIONS		RRH SPEC	CIFICATIONS	RRH SPEC	CIFICATIONS
MANUFACTURER	ALCATEL-LUCENT	MANUFACTURER	NOKIA	MANUFACTURER	NOKIA
MODEL NUMBER	RRH 2x40-07L-DE	MODEL NUMBER	AIRSCALE RRH4T4R B30 100W (AHCA)	MODEL NUMBER	AIRSCALE RRH4T4R B25/B66 320W (AHFIB)
DIMENSIONS (HxWxD)	24.8" x 11.5" x 6.1"	DIMENSIONS (HxWxD)	13.25" X 12.76" X 7.22"	DIMENSIONS (HxWxD)	28.7" x 15.4" x 9.4"
WEIGHT	52.9 LBS	WEIGHT	39.02 LBS	WEIGHT	88.2 LBS
FIBER #	1	FIBER #	1	FIBER #	2


ALCATEL-LUCENT REMOTE RADIO HEAD (RRH) @ ANTENNAS

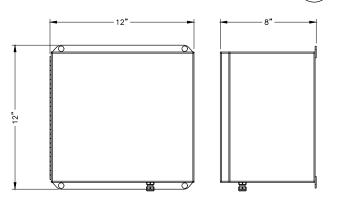

**SURGE ARRESTOR DETAIL** 

SCALE: N.T.S.

FIBER MANAGEMENT BOX @ TOWER DETAIL

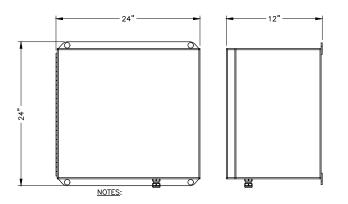

 DIMENSIONS SHOWN AS APPROXIMATE. VERIFY W/ CM PRIOR TO CONSTRUCTION.

FIBER MANAGEMENT BOX @ WIC DETAIL

at&t

DOME COVER

New Cingular Wireless PCS, LLC One AT&T Way Bedminster, NJ 07921

WICKATUNK FA#: 14209075 SITE#: NWL00575

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Dewberry Engineers Inc.

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DAVID E. REVETTE NJ LICENSE No. 24GE05408600

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DRAWN BY:	JC
REVIEWED BY:	GHN
CHECKED BY:	GHN
PROJECT NUMBER:	50110598
JOB NUMBER:	50110612
SITE ADDRESS:	
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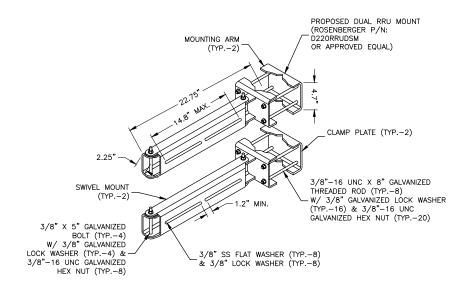
316 TENNENT ROAD MORGANVILLE, NJ 07751 MARLBORO TOWNSHIP

SHEET TITLE


CONSTRUCTION DETAILS IV

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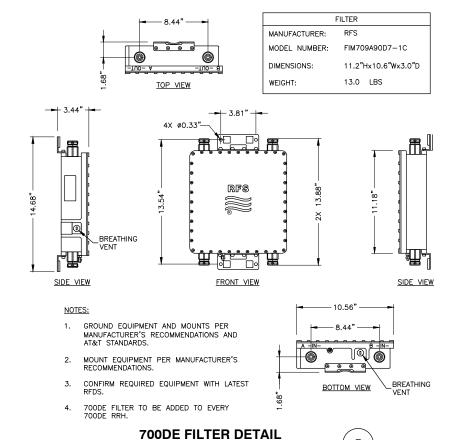
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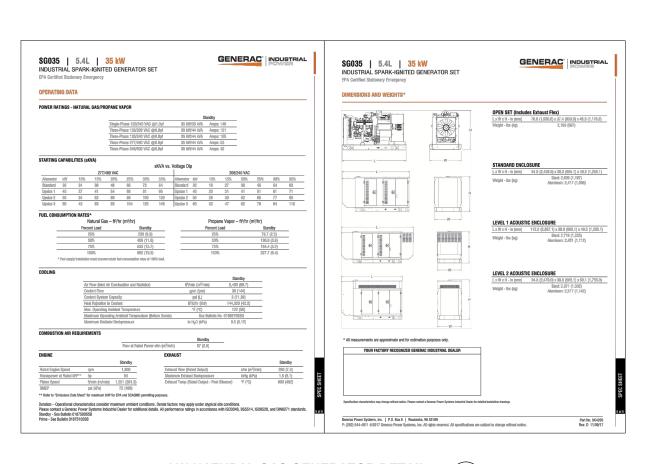







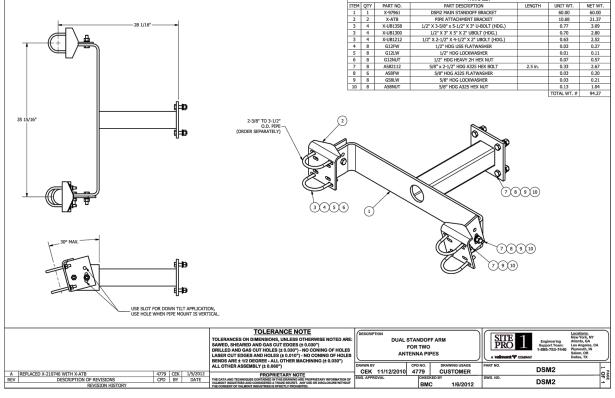

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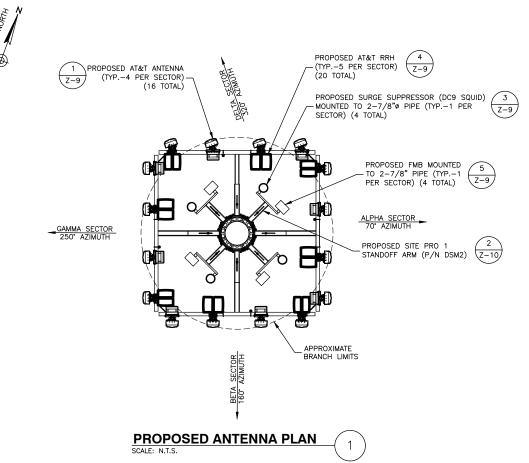
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#### **ANTENNA MOUNTING NOTES:**

- 1. DESIGN AND CONSTRUCTION OF ANTENNA SUPPORTS SHALL CONFORM TO CURRENT ANSI/TIA-222 OR APPLICABLE LOCAL CODES.
- 2. ALL STEEL MATERIALS SHALL BE GALVANIZED AFTER FABRICATION IN ACCORDANCE WITH ASTM A123 "ZINC (HOT-DIP GALVANIZED) COATINGS ON IRON AND STEEL PRODUCTS", UNLESS NOTED OTHERWISE.
- 3. ALL BOLTS, ANCHORS AND MISCELLANEOUS HARDWARE SHALL BE GALVANIZED IN ACCORDANCE WITH ASTM A153 "ZINC-COATING (HOT-DIP) ON IRON AND STEEL HARDWARE", UNLESS NOTED OTHERWISE.
- 4. DAMAGED GALVANIZED SURFACES SHALL BE REPAIRED BY COLD GALVANIZING IN ACCORDANCE WITH ASTM A780.
- 5. ALL ANTENNA MOUNTS SHALL BE INSTALLED WITH LOCK NUTS, DOUBLE NUTS AND SHALL BE TORQUED TO MANUFACTURER'S
- 6. CONTRACTOR SHALL INSTALL ANTENNA PER MANUFACTURER'S RECOMMENDATION FOR INSTALLATION AND GROUNDING.
- 7. ALL UNUSED PORTS ON ANY ANTENNAS SHALL BE TERMINATED WITH A 50-OHM LOAD TO ENSURE ANTENNAS PERFORM AS DESIGNED.
- 8. PRIOR TO SETTING ANTENNA AZIMUTHS AND DOWNTILTS. ANTENNA CONTRACTOR SHALL CHECK THE ANTENNA MOUNT FOR TIGHTNESS AND ENSURE THAT THEY ARE PLUMB. ANTENNA AZIMUTHS SHALL BE SET FROM TRUE NORTH AND BE ORIENTED WITHIN +/- 5% AS DEFINED BY THE RFDS. ANTENNA DOWNTILTS SHALL BE WITHIN +/- 0.5% AS DEFINED BY THE RFDS. REFER TO ND-00246.
- 9. JUMPERS FROM THE TMA'S MUST TERMINATE TO OPPOSITE POLARIZATION'S IN EACH SECTOR.
- 10. CONTRACTOR SHALL RECORD THE SERIAL #, SECTOR, AND POSITION OF EACH ACTUATOR INSTALLED AT THE ANTENNAS AND PROVIDE THE INFORMATION TO AT&T.
- 11. TMA'S SHALL BE MOUNTED ON PIPE DIRECTLY BEHIND ANTENNAS AS CLOSE TO ANTENNA AS FEASIBLE IN A VERTICAL POSITION.
- 12. ANTENNAS SHALL HAVE A 4'-0" MIN CENTER TO CENTER HORIZONTAL SEPARATION.
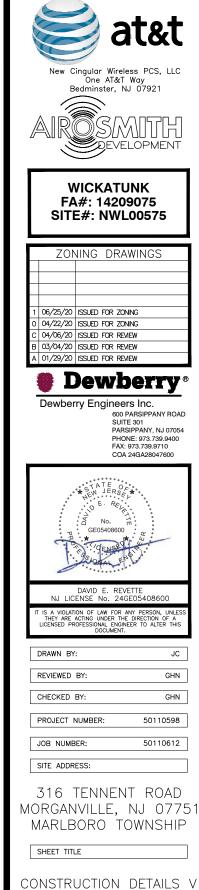
#### **TORQUE REQUIREMENTS:**

- 1. ALL RF CONNECTIONS SHALL BE TIGHTENED BY A TORQUE WRENCH.
- 2. ALL RF CONNECTIONS, GROUNDING HARDWARE AND ANTENNA HARDWARE SHALL HAVE A TORQUE MARK INSTALLED IN A CONTINUOUS STRAIGHT LINE FROM BOTH SIDES OF THE CONNECTION.
- A. RF CONNECTION BOTH SIDES OF THE CONNECTOR.
- B. GROUNDING AND ANTENNA HARDWARE ON THE NUT SIDE STARTING FROM THE THREADS TO THE SOLID SURFACE. EXAMPLE OF SOLID SURFACE: GROUND BAR, ANTENNA BRACKET METAL.
- 3. ALL 8M ANTENNA HARDWARE SHALL BE TIGHTENED TO 9 LB-FT (12 NM).
- 4. ALL 12M ANTENNA HARDWARE SHALL BE TIGHTENED TO 43 LB-FT (58 NM).
- 5. ALL GROUNDING HARDWARE SHALL BE TIGHTENED UNTIL THE LOCK WASHER COLLAPSES AND THE GROUNDING HARDWARE IS NO LONGER
- 6. ALL DIN TYPE CONNECTIONS SHALL BE TIGHTENED TO 18-22 LB-FT (24.4 29.8 NM).
- 7. ALL N TYPE CONNECTIONS SHALL BE TIGHTENED TO 15-20 LB-IN (1.7 2.3 NM).

#### FIBER & POWER CABLE MOUNTING NOTES:

- 1. THE FIBER OPTIC TRUNK CABLES SHALL BE INSTALLED INTO CONDUITS, CHANNEL CABLE TRAYS, OR CABLE TRAY. WHEN INSTALLING FIBER OPTIC TRUNK CABLES INTO A CABLE TRAY SYSTEM, THEY SHALL BE INSTALLED INTO AN INTER DUCT AND A PARTITION BARRIER SHALL BE INSTALLED BETWEEN THE 600 VOLT CABLES AND THE INTER DUCT IN ORDER TO SEGREGATE CABLE TYPES. OPTIC FIBER TRUNK CABLES SHALL HAVE APPROVED CABLE RESTRAINTS EVERY (60) SIXTY FEET AND SECURELY FASTENED TO THE CABLE TRAY SYSTEM. NFPA 70 (NEC) ARTICLE 770 RULES SHALL APPLY.
- 2. THE TYPE TC-ER CABLES SHALL BE INSTALLED INTO CONDUITS, CHANNEL CABLE TRAYS, OR CABLE TRAY AND SHALL BE SECURED AT INTERVALS NOT EXCEEDING (6) SIX FEET. AN EXCEPTION; WHERE TYPE TC-ER CABLES ARE NOT SUBJECT TO PHYSICAL DAMAGE, CABLES SHALL BE PERMITTED TO MAKE A TRANSITION BETWEEN CONDUITS, CHANNEL CABLE TRAYS, OR CABLE TRAY WHICH ARE SERVING UTILIZATION EQUIPMENT OR DEVICES, A DISTANCE (6) SIX FEET SHALL NOT BE EXCEEDED WITHOUT CONTINUOUS SUPPORTING. NFPA 70 (NEC) ARTICLES 336 AND 392 RULES SHALL APPLY.
- 3. WHEN INSTALLING OPTIC FIBER TRUNK CABLES OR TYPE TC-ER CABLES INTO CONDUITS, NFPA 70 (NEC) ARTICLE 300 RULES SHALL

#### **GENERAL CONSTRUCTION NOTES:**

- 1. IT IS THE CONTRACTORS RESPONSIBILITY TO VERIFY ANTENNA, TMAS, DIPLEXERS, AND COAX CONFIGURATION, MAKE AND MODELS PRIOR TO
- 2. ALL CONNECTIONS FOR HANGERS, SUPPORTS, BRACING, ETC. SHALL BE INSTALLED PER TOWER MANUFACTURER'S RECOMMENDATIONS.
- 3. CONTRACTOR SHALL REFERENCE THE TOWER STRUCTURAL ANALYSIS/DESIGN DRAWINGS FOR DIRECTIONS ON CABLE DISTRIBUTION/ROUTING.
- 4. ALL OUTDOOR RF CONNECTORS/CONNECTIONS SHALL BE WEATHERPROOFED, EXCEPT THE RET CONNECTORS, USING BUTYL TAPE AFTER INSTALLATION AND FINAL CONNECTIONS ARE MADE. BUTYL TAPE SHALL HAVE A MINIMUM OF ONE—HALF TAPE WIDTH OVERLAP ON EACH TURN AND EACH LAYER SHALL BE WRAPPED THREE TIMES. WEATHERPROOFING SHALL BE SMOOTH WITHOUT BUCKLING. BUTYL BLEEDING IS NOT
- 5. IF REQUIRED TO PAINT ANTENNAS AND/OR COAX:
- A. TEMPERATURE SHALL BE ABOVE 50° F.
- B. PAINT COLOR MUST BE APPROVED BY BUILDING OWNER/LANDLORD.
- C. FOR REGULATED TOWERS, FAA/FCC APPROVED PAINT IS REQUIRED.
- D. DO NOT PAINT OVER COLOR CODING OR ON EQUIPMENT MODEL NUMBERS.

#### **GENERAL GROUNDING NOTES:**

- ALL CABLES SHALL BE GROUNDED WITH COAXIAL CABLE GROUNDING KITS. FOLLOW THE MANUFACTURER'S
  - A. GROUNDING AT THE ANTENNA LEVEL.
  - GROUNDING AT MID LEVEL, TOWERS WHICH ARE OVER 200'-0", ADDITIONAL CABLE GROUNDING REQUIRED. GROUNDING AT BASE OF TOWER PRIOR TO TURNING HORIZONTAL. GROUNDING OUTSIDE THE EQUIPMENT SHELTER AT ENTRY PORT.

  - GROUNDING INSIDE THE EQUIPMENT SHELTER AT THE ENTRY PORT
- ALL PROPOSED GROUNDING BAR DOWNLEADS ARE TO BE TERMINATED TO THE EXISTING ADJACENT GROUNDING BAR DOWNLEADS A MINIMUM DISTANCE OF 4'-O" BELOW GROUNDING BAR. TERMINATIONS MAY BE EXOTHERMIC OR

#### **GENERAL NOTES:**

- THE CONTRACTOR SHALL BE RESPONSIBLE FOR VERIFYING THE ANTENNA AND THE COAX CONFIGURATION IS THE CORRECT MAKE AND MODELS, PRIOR TO INSTALLATION
- DISTANCE FROM RRH TO SURGE ARRESTOR TO BE A MAXIMUM OF 5 METERS.
- ALL CONNECTIONS FOR HANGERS, SUPPORTS, BRACING, ETC. SHALL BE INSTALLED PER TOWER MANUFACTURER'S SPECIFICATION AND
- 4. CONTRACTOR SHALL REFERENCE THE TOWER STRUCTURAL ANALYSIS/DESIGN DRAWINGS FOR DIRECTIONS ON CABLE DISTRIBUTION/ROUTING.



Bedminster, NJ 07921 **OSMITH**DEVELOPMENT

New Cingular Wireless PCS, LLC One AT&T Way

**WICKATUNK** FA#: 14209075 SITE#: NWL00575

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Dewberry Engineers Inc.

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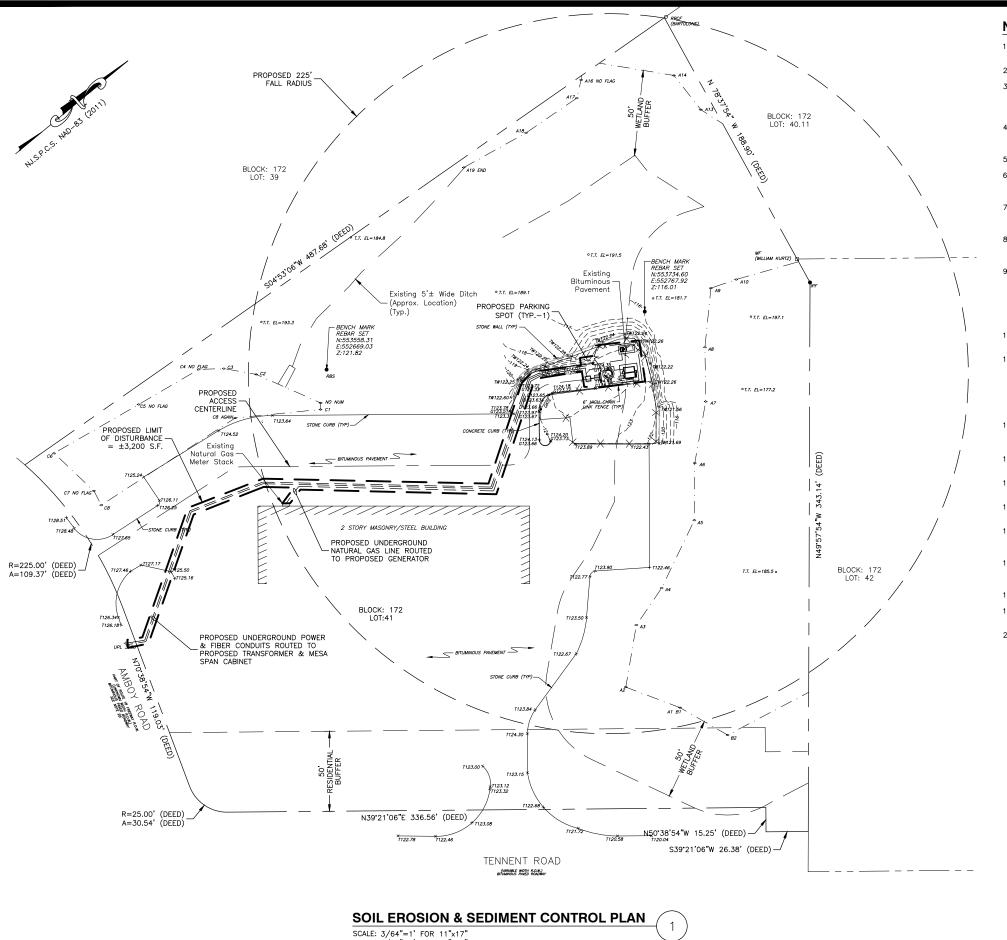
316 TENNENT ROAD MORGANVILLE, NJ 07751 MARLBORO TOWNSHIP

SHEET TITLE

ANTENNA MOUNT DETAILS & NOTES

SHEET NUMBER

7 - 11



- SUBJECT PROPERTIES ARE KNOWN AS BLOCK 172, LOT 42 AS SHOWN ON THE OFFICIAL TAX ASSESSMENT MAP OF THE TOWNSHIP OF MARLBORO, SHEET 48.
- 2. ZONING CLASSIFICATION: IOR: INDUSTRIAL-OFFICE-RESEARCH

APPLICANT: AT&T MORLITY

NEW CINGULAR WIRELESS PCS, LLC ("AT&T") 1 AT&T WAY

BEDMINSTER, NJ 07921

AMBTEN ROAD ASSOCIATES, LLC. 4. PROPERTY OWNER:

44 NIKKI COURT MORGANVILLE, NJ 07751

- 5. SUBJECT TO THE FINDINGS OF A TITLE SEARCH AND SURVEY.
- THIS PLAN IS NOT INTENDED TO DELINEATE OR DEFINE UNDERGROUND UTILITIES. THE USER IS CAUTIONED TO CONTACT NEW JERSEY ONE CALL FOR UTILITY MARKOUTS AT 1-800-272-1000.
- THE PROPOSED USE IS FOR TELECOMMUNICATIONS AND IS NOT INTENDED FOR PERMANENT EMPLOYEE OCCUPANCY. THEREFORE, POTABLE WATER, SANITARY SEWERS, AND ADDITIONAL ON SITE PARKING ARE NOT REQUIRED.
- THE FACILITY SHALL BE VISITED ON THE AVERAGE OF ONCE A MONTH FOR MAINTENANCE AND SHALL BE CONTINUOUSLY MONITORED FROM A REMOTE FACILITY FOR BOTH FIRE AND INTRUSION.
- THE FACILITIES ARE REMOTELY OPERATED AND CONTROLLED, AND AS SUCH, ARE NORMALLY UNMANNED. A COMPUTERIZED EQUIPMENT AND FACILITY ALARM SYSTEM CONTINUOUSLY MONITORS AN EXTENSIVE NUMBER OF OPERATING AND BUILDING FUNCTIONS. UNPLANNED EVENTS WILL TRIGGER ALARM REPORTS TO VERIZON WIRELESS HEADQUARTERS LOCATION IN BEDMINSTER, NJ, RANGING FROM ROUTINE REPORTS TO IMMEDIATE ACTIVATION OF LOCAL PERSONNEL OR EMERGENCY
- 10. A MANUALLY ACTUATED LED WALL PACK LIGHT WITH TIMER IS ATTACHED TO THE EQUIPMENT SHELTER TO PROVIDE AREA LIGHTING DURING MAINTENANCE ONLY.
- 11. ALL MATERIALS, WORKMANSHIP AND CONSTRUCTION FOR THE SITE IMPROVEMENTS SHOWN HEREIN SHALL BE IN ACCORDANCE WITH:
  - 11.1. CURRENT PREVAILING MUNICIPAL AND/OR STATE SPECIFICATIONS, STANDARDS
  - AND REQUIREMENTS.

    11.2. CURRENT PREVAILING UTILITY COMPANY AUTHORITY SPECIFICATIONS, STANDARDS AND REQUIREMENTS.
- CONTRACTOR SHALL CONTACT "GARDEN STATE UNDERGROUND PLANT LOCATION SERVICE" AT 1-800-272-1000 AND LOCATE ALL EXISTING UTILITIES WITHIN THE AREA OF WORK PRIOR TO START OF EXCAVATION.
- 13. CONTRACTOR SHALL COORDINATE & COMPLY WITH EXISTING UTILITY COMPANIES'
- 14. THERE ARE NO PROPOSED ALTERATIONS, IMPROVEMENTS OR RELOCATIONS FOR ANY STREAMS OR EXISTING DRAINAGE STRUCTURES WITHIN THE PROPERTY.
- 15. BASED ON THE NATIONAL WETLANDS INVENTORY MAPS FOR NEW JERSEY, MARLBORO TOWNSHIP NJ QUADRANGLE MAP, WETLANDS ARE NOT PRESENT ON THE SITE.
- 16. THESE DRAWINGS ARE PROVIDED FOR ZONING APPROVAL. CONSTRUCTION LEVEL DRAWINGS WILL BE DEVELOPED SUBSEQUENT TO THE APPROVAL OF THESE
- 17. BEFORE CONSTRUCTION A STRUCTURAL ANALYSIS OF TOWER WILL BE PERFORMED. A COPY OF THE STRUCTURAL ANALYSIS WILL BE SUBMITTED TO THE TOWNSHIP FOR REVIEW WHEN A BUILDING PERMIT APPLICATION IS SUBMITTED.
- 18. NO LANDSCAPING IS PROPOSED AT THIS FACILITY
- A SOIL EROSION AND SEDIMENT CONTROL CERTIFICATION WILL NOT BE REQUIRED SINCE THERE IS LESS THAN 5,000 S.F. DISTURBANCE.
- 20. NO TREES ARE TO BE REMOVED UNDER THIS SUBMITTAL.



New Cingular Wireless PCS, LLC One AT&T Way Bedminster, NJ 07921



**WICKATUNK** FA#: 14209075 SITE#: NWL00575

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	PROJECT NUMBER:	50110598
	JOB NUMBER:	50110612
	SITE ADDRESS:	
	316 TENNE	NT ROAD
Μ	ORGANVILLE	, NJ 07751

MARLBORO TOWNSHIP

SHEET TITLE

SOIL EROSION & SEDIMENT CONTROL PLAN

#### FREEHOLD SOIL CONSERVATION NOTES:

- 1. THE FREEHOLD SOIL CONSERVATION DISTRICT SHALL BE NOTIFIED FORTY-EIGHT (48) HOURS IN ADVANCE OF ANY SOIL DISTURBING ACTIVITY
- 2. ALL SOIL EROSION AND SEDIMENT CONTROL PRACTICES ARE TO BE INSTALLED PRIOR TO SOIL DISTURBANCE, OR IN THEIR PROPER SEQUENCE, AND MAINTAINED UNTIL PERMANENT PROTECTION IS ESTABLISHED.
- 3. ANY CHANGES TO THE CERTIFIED SOIL FROSION AND SEDIMENT CONTROL PLANS WILL REQUIRE THE SUBMISSION OF REVISED SOIL EROSION AND SEDIMENT CONTROL PLANS TO THE DISTRICT FOR RE—CERTIFICATION. THE REVISED PLANS MUST MEET ALL CURRENT STATE SOIL EROSION AND SEDIMENT CONTROL STANDARDS.
- N.J.S.A 4:24-39 ET. SEQ. REQUIRES THAT NO CERTIFICATES OF OCCUPANCY BE ISSUED BEFORE THE DISTRICT DETERMINES THAT A PROJECT OR PORTION THEREOF IS IN FULL COMPLIANCE WITH THE CERTIFIED PLAN AND STANDARDS FOR SOIL EROSION AND SEDIMENT CONTROL IN NEW JERSEY AND A REPORT OF COMPLIANCE HAS BEEN ISSUED. UPON WRITTEN REQUEST FROM THE APPLICANT, THE DISTRICT MAY ISSUE A REPORT OF COMPLIANCE WITH CONDITIONS ON A LOT-BY-LOT OR SECTION-BY-SECTION BASIS, PROVIDED THAT THE PROJECT OR PORTION THEREOF IS IN SATISFACTORY COMPLIANCE WITH THE SEQUENCE OF DEVELOPMENT AND TEMPORARY MEASURES FOR SOIL EROSION AND SEDIMENT CONTROL HAVE BEEN IMPLEMENTED, INCLUDING PROVISIONS FOR STABILIZATION AND SITE WORK.
- ANY DISTURBED AREAS THAT WILL BE LEFT EXPOSED MORE THAN SIXTY (60) DAYS, AND NOT SUBJECT TO CONSTRUCTION TRAFFIC, WILL IMMEDIATELY RECEIVE A TEMPORARY SEEDING. IF THE SEASON PREVENTS THE ESTABLISHMENT OF TEMPORARY COVER, THE DISTURBED AREAS WILL BE MULCHED WITH STRAW, OR EQUIVALENT MATERIAL, AT A RATE OF 2 TO 2 1/2 TONS PER ACRE, ACCORDING TO THE STANDARD FOR STABILIZATION WITH
- 6. IMMEDIATELY FOLLOWING INITIAL DISTURBANCE OR ROUGH GRADING, ALL CRITICAL AREAS SUBJECT TO EROSION (I.E. SOIL STOCKPILES, STEEP SLOPES AND ROADWAY EMBANKMENTS) WILL RECEIVE TEMPORARY SEEDING IN COMBINATION WITH STRAW MULCH OR A SUITABLE EQUIVALENT, AND A MULCH ANCHOR, IN ACCORDANCE WITH STATE
- 7. A SUB-BASE COURSE WILL BE APPLIED IMMEDIATELY FOLLOWING ROUGH GRADING AND INSTALLATION OF IMPROVEMENTS TO STABILIZE STREETS, ROADS, DRIVEWAYS, AND PARKING AREAS. IN AREAS WHERE NO UTILITIES ARE PRESENT, THE SUB-BASE SHALL BE INSTALLED WITHIN FIFTEEN (15) DAYS OF THE PRELIMINARY GRADING.
- THE STANDARD FOR STABILIZED CONSTRUCTION ACCESS REQUIRES THE INSTALLATION OF A PAD OF CLEAN CRUSHED STONE AT POINTS WHERE TRAFFIC WILL BE ACCESSING THE CONSTRUCTION SITE AFTER INTERIOR ROADWAYS ARE PAVED INDIVIDUAL LOTS REQUIRE A STABILIZED CONSTRUCTION ACCESS CONSISTING OF ONE INCH TO TWO INCH (1" 2") STONE FOR A MINIMUM LENGTH OF TEN FEET (10') EQUAL TO THE LOT ENTRANCE I. ALL OTHER ACCESS POINTS SHALL BE BLOCKED OFF
- 9. ALL SOIL WASHED, DROPPED, SPILLED, OR TRACKED OUTSIDE THE LIMIT OF DISTURBANCE OR ONTO PUBLIC RIGHT-OF-WAYS WILL BE REMOVED IMMEDIATELY
- 10. PERMANENT VEGETATION IS TO BE SEEDED OR SODDED ON ALL EXPOSED AREAS WITHIN TEN (10) DAYS AFTER FINAL GRADING.
- 11. AT THE TIME THAT SITE PREPARATION FOR PERMANENT VEGETATIVE STABILIZATION IS GOING TO BE ACCOMPLISHED, ANY SOIL THAT WILL NOT PROVIDE A SUITABLE ENVIRONMENT TO SUPPORT ADEQUATE VEGETATIVE GROUND COVER SHALL BE REMOVED OR TREATED IN SUCH A WAY THAT IT WILL PERMANENTLY ADJUST THE SOIL CONDITIONS AND RENDER IT SUITABLE FOR VEGETATIVE GROUND COVER. IF THE REMOVAL OR TREATMENT OF THE SOIL WILL NOT PROVIDE SUITABLE CONDITIONS, NON-VEGETATIVE MEANS OF PERMANENT GROUND STABILIZATION WILL HAVE TO BE EMPLOYED.
- 12. IN ACCORDANCE WITH THE STANDARD FOR MANAGEMENT OF HIGH ACID PRODUCING SOILS. IN ACCURIDANCE WITH THE STANDARD FOR MANAGEMENT OF HIGH ACID PRODUCING SOIL ANY SOIL HAVING A PH OF 4 OR LESS OR CONTAINING IRON SULFIDES SHALL BE ULTIMATELY PLACED OR BURIED WITH LIMESTONE APPLIED AT THE RATE OF 10 TONS/ACRE, (OR 450 LBS/1,000 SQ FT OF SURFACE AREA) AND COVERED WITH A MINIMUM OF 12" OF SETTLED SOIL WITH A PH OF 5 OR MORE, OR 24" WHERE TREES OR SHRUBS ARE TO BE PLANTED.
- 13. CONDUIT OUTLET PROTECTION MUST BE INSTALLED AT ALL REQUIRED OUTFALLS PRIOR TO
- 14. UNFILTERED DEWATERING IS NOT PERMITTED. NECESSARY PRECAUTIONS MUST BE TAKEN DURING ALL DEWATERING OPERATIONS TO MINIMIZE SEDIMENT TRANSFER. ANY DEWATERING METHODS USED MUST BE IN ACCORDANCE WITH THE STANDARD FOR DEWATERING.
- 15. SHOULD THE CONTROL OF DUST AT THE SITE BE NECESSARY, THE SITE WILL BE SPRINKLED UNTIL THE SURFACE IS WET, TEMPORARY VEGETATIVE COVER SHALL BE ESTABLISHED OR MULCH SHALL BE APPLIED AS REQUIRED BY THE STANDARD FOR DUST
- 16. STOCKPILE AND STAGING LOCATIONS ESTABLISHED IN THE FIELD SHALL BE PLACED WITHIN THE LIMIT OF DISTURBANCE ACCORDING TO THE CERTIFIED PLAN. STAGING AND STOCKPILES NOT LOCATED WITHIN THE LIMIT OF DISTURBANCE WILL REQUIRE CERTIFICATION OF A REVISED SOIL EROSION AND SEDIMENT CONTROL PLAN. CERTIFICATION OF A NEW SOIL EROSION AND SEDIMENT CONTROL PLAN MAY BE REQUIRED FOR THESE ACTIVITIES IF AN AREA GREATER THAN 5,000 SQUARE FEET IS DISTURBED.
- 17. ALL SOIL STOCKPILES ARE TO BE TEMPORARILY STABILIZED IN ACCORDANCE WITH SOIL EROSION AND SEDIMENT CONTROL NOTE #6.
- 18. THE PROPERTY OWNER SHALL BE RESPONSIBLE FOR ANY EROSION OR SEDIMENTATION THAT MAY OCCUR BELOW STORMWATER OUTFALLS OR OFFSITE AS A RESULT OF CONSTRUCTION OF THE PROJECT.

#### **CONSTRUCTION SEQUENCE:**

WORK TO BE PERFORMED APPROXIMATE DURATION INSTALL SOIL EROSION CONTROL MEASURES. 1 DAY CLEAR AREA
CONSTRUCT FOUNDATION 0.5 DAYS 2 DAYS INSTALL EQUIPMENT 10 DAYS INSTALL UNDERGROUND UTILITIES 2 DAYS INSTALL PERMANENT STABILIZATION MEASURES (INCLUDING GRAVEL SURFACES, FENCING AND SEEDING)

#### NOTE:

1. CONSTRUCTION SHALL BE STARTED AND COMPLETED AS A SINGLE PHASE.

#### TOPSOIL STOCKPILE PROTECTION:

- CONSTRUCT TEMPORARY DIVERSION BERM AND/OR HAY BALE BARRIER AROUND STOCKPILE AREA AS REQUIRED.
- 2. APPLY LIMESTONE AT A RATE OF 90 LBS/1000 S.F.
- 3. APPLY FERTILIZER (10-20-10) AT A RATE OF 11 LB/1000 S.F.
- 4. APPLY PERENNIAL RYEGRASS AT A RATE OF 1 LB/1000 S.F.
- 5. MULCH WITH UNROTTED SALT HAY OR SMALL GRAIN STRAW IMMEDIATELY AFTER SEEDING. APPLY AT A RATE OF 90 LBS/1000 S.F.

#### **TEMPORARY STABILIZATION SPECIFICATIONS:**

- 1. APPLY GROUND LIMESTONE AT A RATE OF 2 TONS/ACRE TO A DEPTH OF 4 INCHES.
- 2. APPLY FERTILIZER (10-20-10) AT A RATE OF 500 LBS/ACRE OR 11 LBS/1000 S.F WITH 50% WATER INSOLUBLE NITROGEN TO A DEPTH OF 4 INCHES.
- 3. APPLY SEED MIXTURE:

PERENNIAL RYEGRASS AT 100 LBS/ACRE AT A DEPTH OF 1/2 INCH.

APPLY SEED MIXTURE UNIFORMLY BY HAND, CYCLONE (CENTRIFUGAL) SEEDER, DROP SEEDER, DRILL OR CULTIPACKER SEEDER. EXCEPT FOR DRILLED, HYDROSEEDED OR CULTIPACKED SEEDINGS, SEED SHALL BE INCORPORATED INTO THE SOIL, TO A DEPTH OF 1/4 TO 1/2 INCH, BY RAKING OR DRAGGING. DEPTH OF SEED PLACEMENT MAY BE 1/4 INCH DEFPER ON COARSE TEXTURED SOIL.

- 4. PLANT SEED BETWEEN MARCH 1 AND MAY 15 OR BETWEEN AUGUST 15 AND OCTOBER 1,
- 5. MULCH WITH WITH UNROTTED SMALL GRAIN STRAW, HAY FREE OF SEEDS IMMEDIATELY AFTER SEEDING. APPLY AT A RATE OF 70 TO 90 LBS/1000 S.F., ACCORDING TO THE N.J. STANDARD. SPREAD MULCH UNIFORMLY BY HAND SO THAT APPROXIMATELY 95% OF THE SOIL SURFACE IS COVERED.
- 6. ANCHOR MULCH IMMEDIATELY AFTER PLACEMENT BY ONE OF THE FOLLOWING METHODS:
- 6.1. PEG AND TWINE: DRIVE 8 TO 10 INCH WOODEN PEGS TO WITHIN 2 TO 3 INCHES OF THE SOIL SURFACE EVERY 4 FEET IN ALL DIRECTIONS. STAKES MAY BE DRIVEN BEFORE OR AFTER APPLYING MULCH. SECURE MULCH TO SOIL SURFACE BY STRETCHING TWINE BETWEEN PEGS IN A CRIS-CROSS AND A SQUARE PATTERN.
- SECURE TWINE AROUND EACH PEG WITH TWO OR MORE ROUND TURNS. 6.2. MULCH NETTINGS: STAPLE PAPER, JUTE, COTTON, OR PLASTIC NETTINGS TO THE SOIL SURFACE. USE A DEGRADABLE NETTING IN AREAS TO BE MOWED

#### PERMANENT STABILIZATION SPECIFICATIONS:

- 1. PERMANENT STABILIZATION SPECIFICATIONS BELOW ARE BASED ON THE STANDARDS FOR SOIL EROSION AND SEDIMENT CONTROL IN NEW JERSEY FOR COMMERCIAL APPLICATIONS WITH WELL TO MODERATELY WELL DRAINED SOILS WITH THE PLANT HARDNESS ZONE 6B.
- 2. APPLY TOPSOIL TO A DEPTH OF 5 INCHES
- 3. APPLY GROUND LIMESTONE AT A RATE OF 90 LBS/1000 S.F.
- APPLY FERTILIZER (10-10-10) AT A RATE OF 500 LBS/ACRE OR 11 LBS/1000 S.F WITH 50% WATER INSOLUBLE NITROGEN INCORPORATED INTO THE SURFACE 4 INCHES
- 5. APPLY SEED MIXTURE:


HARD FESCUE AT 130 LBS/ACRE, CHEWINGS FESCUE AT 45 LBS/ACRE, STRONG CREEPING RED FESCUE AT 45 LBS/ACRE AND PERENNIAL RYEGRASS AT 10 LBS/ACRE OR APPROVED FOUAL.

APPLY SEED MIXTURE UNIFORMLY BY HAND, CYCLONE (CENTRIFUGAL) SEEDER, DROP SEEDER, DRILL OR CULTIPACKER SEEDER, EXCEPT FOR DRILLED, HYDROSEEDEN, OR CULTIPACKED SEEDINGS, SEED SHALL BE INCORPORATED INTO THE SOIL WITHIN 24 HOURS OF SEEDBED PREPARATION TO A DEPTH OF 1/4 TO 1/2 INCH, BY RAKING OR DRAGGING. DEPTH OF SEED PLACEMENT MAY BE 1/4 INCH DEEPER ON COARSE-TEXTURED SOIL.

- 6. PLANT SEED BETWEEN AUGUST 15 AND OCTOBER 1, IF POSSIBLE
- 7. MULCH WITH UNROTTED SMALL GRAIN STRAW, HAY FREE OF SEEDS IMMEDIATELY AFTER SEEDING. APPLY AT A RATE OF 70 TO 90 LBS/1000 S.F., ACCORDING TO THE N.J STANDARD. SPREAD MULCH UNIFORMLY BY HAND OR SO THAT AT LEAST 85% OF T SOIL SURFACE IS COVERED.
- 8. ANCHOR MULCH IMMEDIATELY AFTER PLACEMENT BY ONE OF THE FOLLOWING METHODS:
- 8.1. PEG AND TWINE: DRIVE 8 TO 10 INCH WOODEN PEGS TO WITHIN 2 TO 3 INCHES OF THE SOIL SURFACE EVERY 4 FEET IN ALL DIRECTIONS. STAKES MAY BE DRIVEN BEFORE OR AFTER APPLYING MULCH. SECURE MULCH TO SOIL SURFACE BY STRETCHING TWINE WITHIN PEGS IN A CRISS-CROSS AND A SQUARE PATTERN. SECURE TWINE AROUND EACH PEG WITH TWO OR MORE ROUND TURNS.
- 8.2. MULCH NETTINGS: STAPLE PAPER, JUTE, COTTON, OR PLASTIC NETTINGS TO THE SOIL SURFACE, USE A DEGRADABLE NETTING IN AREAS TO BE MOWED.
- 9. IF SOIL MOISTURE IS DEFICIENT, SUPPLY NEW SEEDING WITH ADEQUATE WATER (A MINIMUM OF 1/4 INCH APPLIED UP TO TWICE A DAY UNTIL VEGETATION IS WELL

#### **GENERAL NOTES:**

- STONE TRACKING PAD WILL BE USED IN ACCORDANCE WITH CONSTRUCTION MITIGATION MEASURES ISSUED BY THE TOWNSHIP OF WEST MILFORD PLANNING BOARD.
- 2. REFER TO SHEET Z-2 FOR OVERALL SITE PLAN AND SHEET SC-1 FOR PARTIAL SITE

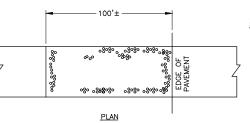

NOTE:

- 1. CRUSHED STONE TRACKING PAD SHALL BE INSTALLED AT A MINIMUM OF 100 FEET FROM THE EDGE OF WORK LIMITS (IF CONDITIONS DICTATE) IMMEDIATELY AFTER ROUGH GRADING ROAD. BLANKET (2) 1/2" CRUSHED STONE, 6" THICK) SHALL BE PLACED DIRECTLY OVER A FILTER FABRIC TO PREVENT STONE FROM WORKING INTO SOIL UNDER HEAVY TRAFFIC
- PROVIDE APPROPRIATE TRANSITION BETWEEN STABILIZED CONSTRUCTION ENTRANCE AND EXISTING DRIVEWAY.

SLOPES 3:1 OR

TO RE

TEMPORARILY

SEEDED WITHIN 30 DAYS

STABILIZED

SILT FENCE TO BE

4

6" STONE FILTER BERM AROUND PERIMETER OF

STOCKPILE


Existing

## STABILIZED CONSTRUCTION ENTRANCE

(MIN.) (MIN.) (MIN.) STEEL SNOWFENCE POSTS @ 2'-0" O.C. 4' HIGH, PLACED AT DRIP LINE OF INTERFERING \_ 4'-0" (MIN.) BRANCHES AROUND PERIMETER


NOTE:

THE LANDSCAPE ARCHTIECT SHALL DETERMINE WHICH TREES SHALL REQUIRE PROTECTION DURING CONTSTRUCTION AND SHALL DETERMINE THE METHOD OF PROTECTION TO BE EMPLOYED. WHERE TRIMMING IS NECESSARY IT SHALL TO THE LANDSCAPE ARCHITECT'S DIRECTIONS BY A LICENSED TREE SURGEON

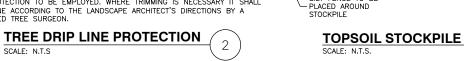

#### NOTE:

1. CONSTRUCTION SHALL BE STARTED AND COMPLETED AS A SINGLE PHASE.

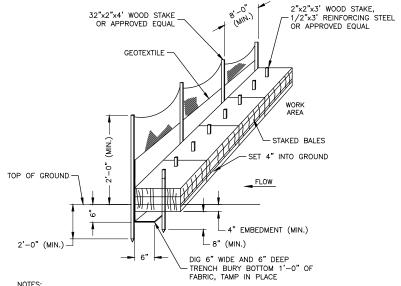

#### NOTES:

- 1. HAY BALE SHALL BE PLACED PRIOR TO CONSTRUCTION ON THE CONTOUR AND IN A ROW WITH ENDS TIGHTLY ABUTTING THE ADJACENT HAY BALE.
- 2. GEOTEXTILE FABRIC SHALL BE SECURED TO POST WITH METAL FASTENERS AND REINFORCEMENT BETWEEN FASTENER AND FABRIC.
- 3. EACH HAYBALE SHALL BE EMBEDDED IN THE SOIL A MINIMUM OF 4 INCHES, AND PLACED SO THE BINDINGS ARE HORIZONTAL
- 4. HAY BALE SHALL BE SECURELY ANCHORED IN PLACE BY EITHER TWO STAKES OR REBARS DRIVEN THROUGH THE HAYBALE. THE FIRST STAKE IN EACH HAYBALE SHALL BE DRIVEN TOWARD THE PREVIOUSLY LAID HAYBALE AT AN ANGLE TO FORCE THE THE HAY BALE TOGETHER STAKES SHALL BE DRIVEN FLUSH WITH THE HAYBALE
- 5. INSPECTION SHALL BE FREQUENT AND REPAIR OR REPLACEMENT SHALL BE MADE PROMPTLY AS NEEDED.
- UPON COMPLETION OF CONSTRUCTION AND STABILIZATION OF ALL DISTURBED AREAS, EROSION CONTROL MEASURES ARE TO BE REMOVED.

#### SILT FENCE-HAY BALE BARRIER DETAIL

SCALF: N.T.S



New Cingular Wireless PCS, LLC One AT&T Way Bedminster, NJ 07921



WICKATUNK FA#: 14209075 SITE#: NWL00575

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Dewberry Engineers Inc.

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REVETTE NJ LICENSE No. 24GE05408600

IS A VIOLATION OF LAW FOR ANY PERSON, THEY ARE ACTING UNDER THE DIRECTION I LICENSED PROFESSIONAL ENGINEER TO ALTE DOCUMENT.

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316 TENNENT ROAD MORGANVILLE, NJ 0775 MARLBORO TOWNSHIP

SHEET TITLE

JOB NUMBER:

SOIL EROSION, SEDIMENT CONTROL NOTES & DETAILS